

STATE OF HAWAII

DEPARTMENT OF TRANSPORTATION


DIVISION HIGHWAYS HONOLULU, HAWAII


PLANS FOR

LIKELIKE HIGHWAY WILSON TUNNEL ELECTRICAL **IMPROVEMENTS**

HIGHWAY PROJECT NO. HWY-OT-SMP-01

DISTRICT OF HONOULULU ISLAND OF OAHU

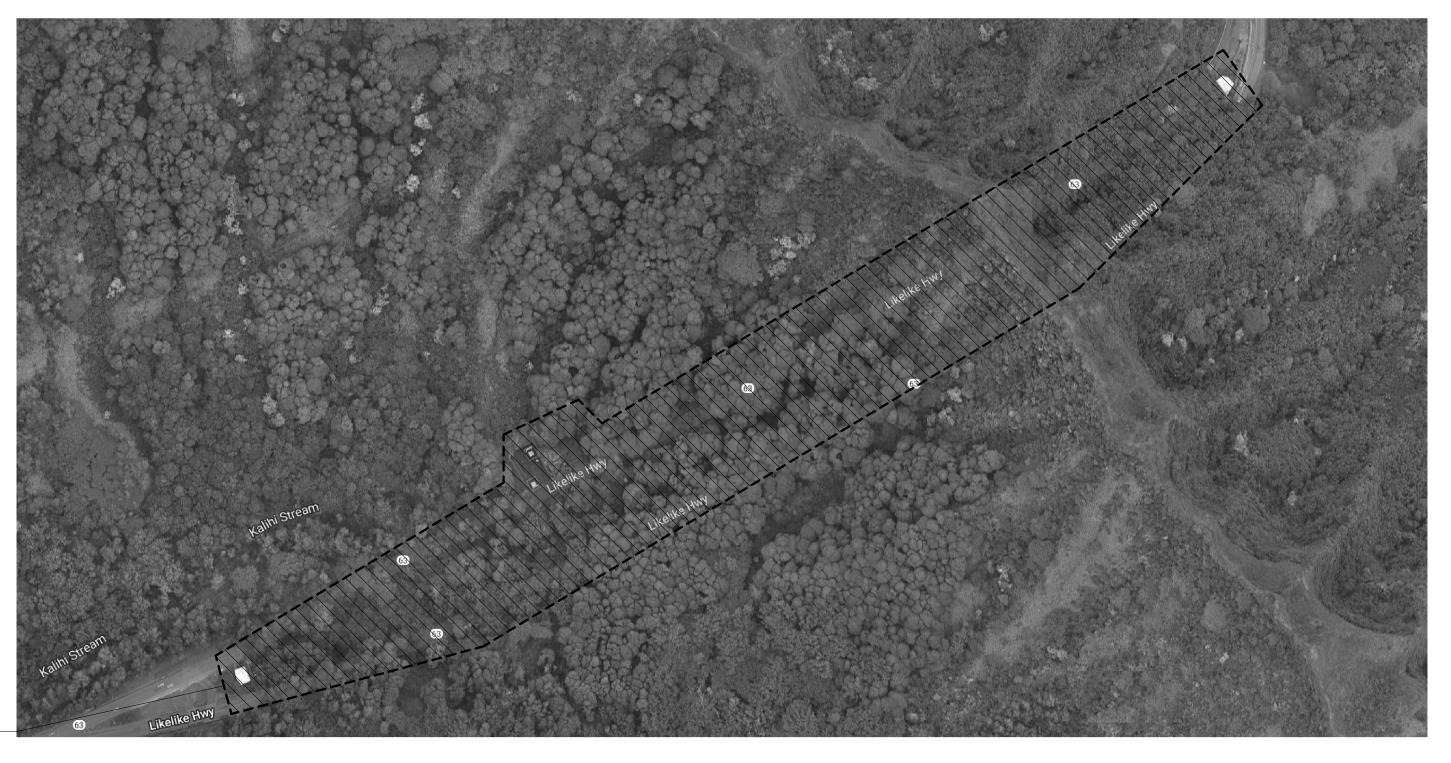

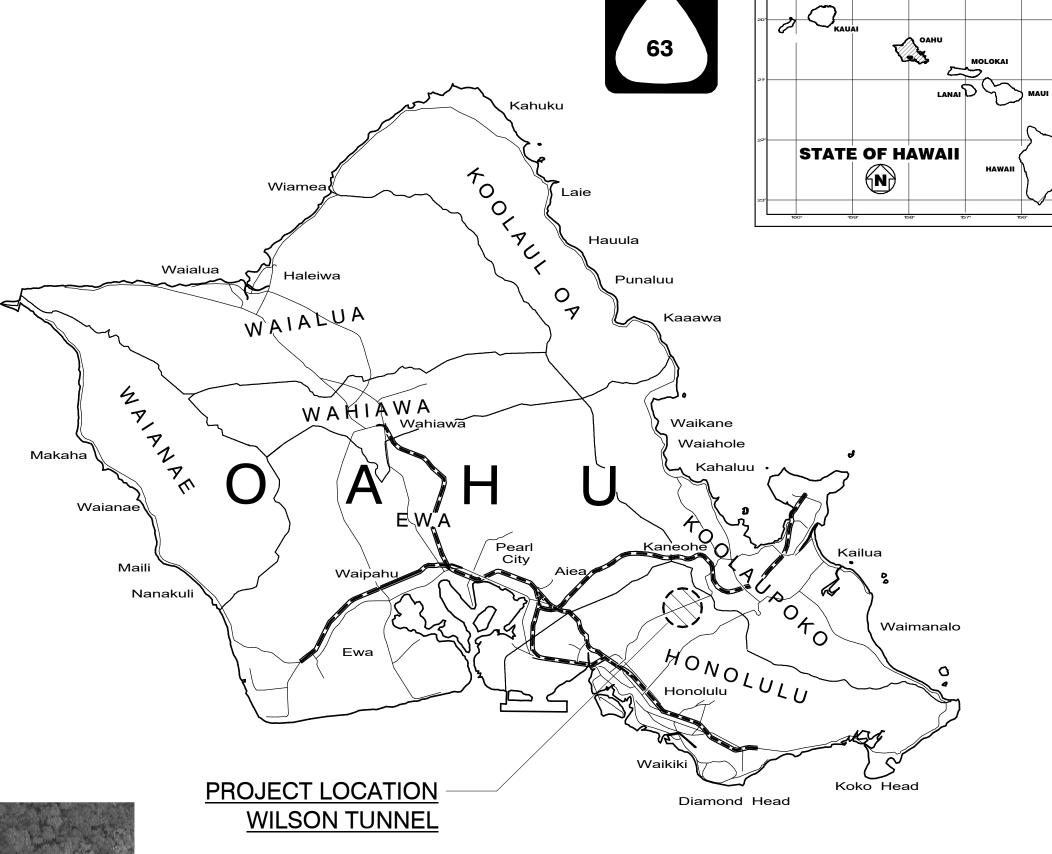

HIGHWAY DIST. NO.

SCALE IN MILES

FISCAL YEAR

HIGHWAY


PROJ. NO.

SHEET NO.

SHEETS


FEDERAL AID INTERSTATE PROJECTS PREVIOUSLY OR UNDER CONSTRUCTION CONSTRUCTED

MILE POST <u>5.75</u> TO MILE POST <u>6.28</u>

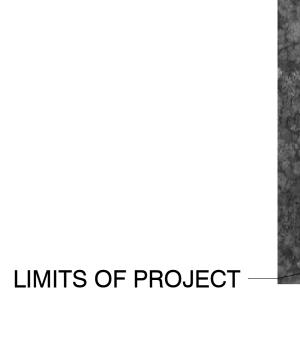


1 PROJECT SITE PLAN

N.T.S.

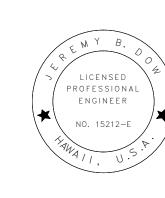

THIS WORK WAS PREPARED BY ME OR UNDER MY SUPERVISION.

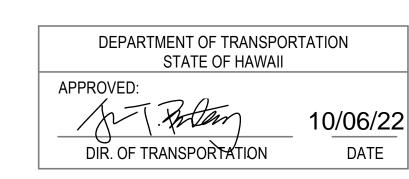

HIGHWAY HIGHWAY FISCAL SHEET TOTAL STATE DIST. NO. PROJ. NO. YEAR NO. SHEETS HWY-OT-SMP-01 2022 E1 HAWAII HAW.

RACEWAYS & CONDUCTORS

INSTALL PER NEC 210.4

RACEWAY AND CONDUCTORS

RACEWAY AND CONDUCTORS - NEW WORK

POWER

- DUPLEX RECEPTACLE, 20 AMP, 125 VOLT, 3 WIRE, +18" AFF OR AS NOTED
- DUPLEX RECEPTACLE, 20 AMP, 125 VOLT, 3 WIRE, MOUNTED 6" ABOVE COUNTER OR AS NOTED
- DOUBLE DUPLEX RECEPTACLE, 20 AMP, 125 VOLT, 3 WIRE, +18" AFF OR AS NOTED
- FLUSH FLOOR MOUNTED POWER RECEPTACLE, 20 AMP, 125 VOLT, 3 WIRE, HUBBELL B2529 FLOOR BOX, S3925 BRASS COVER
- NEMA OUTLET, RATING AS INDICATED, +18" AFF OR AS NOTED
 - \bigcirc JUNCTION BOX
 - JUNCTION BOX, FLOOR MOUNTED
 - JUNCTION BOX, WALL MOUNTED
 - CLOCK RECEPTACLE
 - **EQUIPMENT CONNECTION**
 - MOTOR CONNECTION, FURNISHED BY MECHANICAL, INSTALLED BY ELECTRICAL
 - MAGNETIC STARTER,
 - FURNISHED BY MECHANICAL, INSTALLED BY ELECTRICAL
 - DISCONNECT SWITCH, FURNISHED BY MECHANICAL, INSTALLED BY ELECTRICAL
 - EQUIPMENT MOTOR SWITCH. FURNISHED BY MECHANICAL, INSTALLED BY ELECTRICAL

HANDHOLE

MANHOLE

SYMBOL



VIEW REFERENCE



CENTERLINE

NORTH ARROW



NOTE REFERENCE

KEYNOTE REFERENCE

LUMINAIRE DESIGNATION. REFER TO LUMINAIRE SCHEDULE

ABBREVIATIONS


- ARC FAULT BREAKER
- CONDUIT
- CURRENT LIMITING FUSE
- COPIER
- DISHWASHER
- EVENING LIGHT, TIMESWITCH CONTROLLED
- ELECTRONIC WATER COOLER
- GROUND FAULT CIRCUIT INTERRUPTER
- HACR BREAKER
- HAWAIIAN ELECTRIC COMPANY
- HELCO HAWAI'I ELECTRIC LIGHT COMPANY (BIG ISLAND)
- INSULATED GROUND CIRCUIT(S)
- KAUA'I ISLAND UTILITY COOPERATIVE
- LIGHT(S)
- LIGHTING CONTACTOR
- LOCKABLE BREAKER
- MAIN DISTRIBUTION PANEL
- MAUI ELECTRIC COMPANY
- MICROWAVE
- NIGHT LIGHT, TIMESWITCH CONTROLLED
- PROVISIONS FOR BREAKER
- RECEPTACLE(S)
- REFRIGERATOR
- TAMPER RESISTANT

SPARE BREAKER

- THERMOPLASTIC BRAIDED WEATHER PROOF
- WEATHERPROOF
- NEMA 4X STAINLESS STEEL

GENERAL NOTES

- INSTALLATION SHALL COMPLY WITH THE 2017 NATIONAL ELECTRICAL CODE, LOCAL AMENDMENTS, AND NECA STANDARDS OF INSTALLATION.
- EXISTING EQUIPMENT INFORMATION SHOWN ON THESE DRAWINGS SHOULD BE FIELD VERIFIED. CONFIRM EQUIPMENT LOCATIONS WITH OWNER AND ADJUST AS REQUIRED.
- ALL CONDUCTOR SIZES SHOWN ARE BASED ON COPPER.
- MAINTAIN MINIMUM 6" CLEARANCE BETWEEN CONDUIT AND PIPING. MAINTAIN 12" CLEARANCE BETWEEN CONDUIT AND HEAT SOURCES SUCH AS FLUES, HEATING PIPES, AND HEATING APPLIANCES.
- VERIFY CEILING TYPES THROUGHOUT; PROVIDE ALL MOUNTING ACCESSORIES, TRIM, FLANGES, OUTLET BOXES, ETC. FOR A COMPLETE AND FINISHED INSTALLATION.
- ALL EQUIPMENT AND MATERIALS ARE UL LISTED WHERE LISTING IS AVAILABLE FOR THAT TYPE OF EQUIPMENT OR CONFORM TO ANSI OR NEMA STANDARDS.
- WORKMANSHIP SHALL CONFORM TO CONSTRUCTION PRACTICES RECOMMENDED BY THE AMERICAN ELECTRICIANS HANDBOOK BY CROFT (LATEST EDITION) AND WILL BE SUBJECTED TO THE APPROVAL OF THE AGENCY THAT HAS JURISDICTION AND THE ENGINEER OF RECORD.
- TEST COMPLETED INSTALLATION AND CORRECT ALL DEFICIENCIES FOUND IN THE SYSTEM OR INSTALLATION.
- ALL EXISTING CIRCUITS AFFECTED DURING ELECTRICAL INSTALLATION SHALL BE RESTORED TO THEIR ORIGINAL OPERATING CONDITION.
- 10. THE CONTRACTOR SHALL MAKE EVERY EFFORT TO VERIFY THE LOCATION OF EXISTING UTILITIES PRIOR TO DEMOLITION, DIGGING, TRENCHING, OR SIMILAR OPERATIONS. COORDINATE WITH THE CONSTRUCTION MANAGER OR OWNERS REPRESENTATIVE TO REVIEW EACH WORK AREA PRIOR TO BEGINNING WORK.
- 11. ALL EXISTING CONDITION SHOWN ON THE DRAWINGS IS FROM THE BEST AVAILABLE AS-BUILT DRAWINGS AND LIMITED SITE-SURVEY. CONTRACTOR SHALL FIELD VERIFY THE ACTUAL CONDITION BEFORE CONSTRUCTION AND REPORT ANY DISCREPANCIES TO THE ENGINEER.
- 12. ELECTRICAL DRAWINGS ARE DIAGRAMMATIC AND DO NOT SHOW ALL CONDUIT AND CONNECTIONS BETWEEN RESPECTIVE DEVICES, FIXTURES, AND EQUIPMENT. CONTRACTOR TO DETERMINE EXACT ROUTING OF CONDUIT CONNECTIONS BETWEEN RESPECTIVE DEVICES, FIXTURES, AND EQUIPMENT. REFER TO ARCHITECTURAL AND MECHANICAL PLANS FOR EXACT LOCATIONS.
- 13. PROVIDE CIRCUIT IDENTIFICATION LABEL ON DEVICES, LIGHT SWITCHES, AND EQUIPMENT.
- 14. SCAN REBAR PRIOR TO DRILLING. ALERT ENGINEER IF ANY REBAR IS CUT.

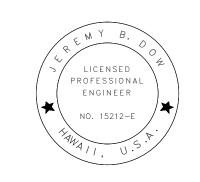

THIS WORK WAS PREPARED BY ME OR UNDER MY SUPERVISION. EXPIRATION DATE OF THE LICENSE

STATE OF HAWAI'I **DEPARTMENT OF TRANSPORTATION** HIGHWAYS DIVISION

ABBREVIATIONS, SYMBOLS LEGEND, AND SHEET INDEX LIKELIKE HIGHWAY WILSON TUNNEL ELECTRICAL **IMPROVEMENTS** HWY-OT-SMP-01

Scale: N.T.S.

SHEET No. E1 OF 19 SHEETS

- A. THE CONTRACTOR SHALL EXAMINE THE DRAWINGS AND SPECIFICATIONS FOR ALL PARTS OF THE WORK. IF ANY DISCREPANCIES EXIST BETWEEN THE PLANS FOR HIS WORK AND THE PLANS FOR WORK OF OTHERS, HE SHALL REPORT SUCH DISCREPANCIES TO THE ARCHITECT AND SHALL OBTAIN WRITTEN INSTRUCTIONS. ANY CHANGES IN THE WORK COVERED BY THIS SPECIFICATION MADE NECESSARY THROUGH NEGLECT OR FAILURE OF THE CONTRACTOR TO REPORT SUCH DISCREPANCIES SHALL BE MADE BY AND AT THE EXPENSE OF THE CONTRACTOR.
- B. THE SPECIFICATIONS AND DRAWINGS ARE INTENDED TO COVER A COMPLETE INSTALLATION OF SYSTEMS. EVERYTHING THAT IS SPECIFIED, SCHEDULED OR MENTIONED BY ONE SHALL BE BINDING AS IF CALLED BY BOTH.
- C. DEFINITIONS
 - 1) "PROVIDE" MEANS "FURNISH AND INSTALL".
 - "WIRING" MEANS "PROVIDE ALL DEVICES, RACEWAYS, CONDUCTORS, CABLES, PROTECTIVE EQUIPMENT, ETC., FOR COMPLETE ELECTRIC CIRCUIT OR SYSTEM.
- D. SCOPE OF WORK:
 - 1) THE ELECTRICAL CONTRACTOR SHALL PROVIDE ALL LABOR, MATERIALS AND EQUIPMENT REQUIRED TO EXECUTE WORK AND SHALL OBTAIN AND PAY FOR ALL PERMITS, INSPECTIONS AND ASSOCIATED FEES.
 - 2) THE ELECTRICAL CONTRACTOR SHALL FURNISH TO THE ARCHITECT, AT THE COMPLETION OF THE PROJECT A FINAL INSPECTION CERTIFICATE FROM THE LOCAL INSPECTION AUTHORITY.
 - 3) WORK SHALL INCLUDE BUT SHALL NOT BE LIMITED TO:
 - A) ELECTRICAL DISTRIBUTION SYSTEM
 - B) POWER WIRING
 - C) FINAL CONNECTIONS TO ALL EQUIPMENT
- E. WORK BY OTHERS:
 - 1) PRIOR TO COMMENCING, COORDINATE TIME SCHEDULING, PATCHING, INSTALLATION, HOOK-UPS, AND MISCELLANEOUS PROCEDURES WITH ANY AND ALL OTHER CONTRACTORS THAT WILL BE INVOLVED TO EXPEDITE THE COMPLETION OF THE CONTRACT.
 - 2) ELECTRICAL CONTRACTOR SHALL NOTIFY OTHER TRADES AND SUPPLIERS OF PROJECT VOLTAGES
- F. RECORD DRAWINGS:

THE CONTRACTOR SHALL MAINTAIN AN ACCURATE AND ADEQUATE RECORD OF EACH CHANGE IT OCCURS, REGARDLESS OF HOW ORDERED. AT NO ADDITIONAL CHARGE TO THE OWNER, AFTER FINAL INSPECTION, PREPARE A REPRODUCIBLE COPY OF "AS-BUILT" ELECTRICAL DRAWINGS FROM SITE COPY AND TURN OVER TO ARCHITECT/OWNER.

G. REGULATIONS AND CODES:

THE ENTIRE ELECTRICAL INSTALLATION SHALL COMPLY WITH THE N.E.C., IEEE, CSA AND THE RULES, REGULATIONS AND/OR ORDINANCES OF THE GOVERNING AUTHORITY SHALL BE MADE BY THE ELECTRICAL CONTRACTOR WITHOUT ADDITIONAL COST TO THE OWNER.

PHASING NOTES:

- A. POWER OUTAGES WILL BE SCHEDULED AND COORDINATED WITH THE DEPARTMENT OF TRANSPORTATION 14 DAYS MINIMUM IN ADVANCE. OUTAGE DURATIONS SHALL NOT EXCEED 4 HOURS.
- B. CONSTRUCT NEW 5KV FEEDER SYSTEM CABLES/EQUIPMENT AND MAKE READY FOR FINAL TERMINATION TO EXISTING SYSTEMS WHERE ELECTRICAL SITE CONDITIONS PERMIT. KEEP EXISTING SYSTEMS OPERATIONAL TO THE MAXIMUM EXTENT POSSIBLE UP TO THE TIME WHEN THE CHANGEOVER FROM EXISTING TO NEW WILL BE MADE.

2. PRODUCTS

- A. MATERIALS SHALL BE U.L. APPROVED UNLESS OTHERWISE REQUIRED AND SHALL CONFORM TO APPLICABLE N.E.M.A. AND N.E.C. STANDARDS.
- B. RACEWAYS SHALL BE RIGID METAL CONDUIT OR AS NOTED. MANUFACTURED AND INSTALLED ACCORDING TO N.E.C. ARTICLE 344, UNLESS OTHERWISE NOTED. ALL RACEWAYS SHALL HAVE A PULL-WIRE.
- C. PROVIDE #6 AWG MINIMUM 600V INSULATED GROUND WIRE (GREEN) INSTALLED FOR THE ENTIRE LENGTH OF THE TRAY, UNLESS THE TRAY IS LISTED FOR EQUIPMENT GROUND USE.
- D. REQUIRED BENDS, FITTINGS, JUNCTION BOXES, ETC., WHETHER OR NOT THEY ARE SHOWN ON DRAWINGS SHALL BE INSTALLED TO SATISFY ALL CODES AND STANDARDS OF GOOD PRACTICE.
- E. HARDWARE, SUPPORT, BACKING ETC., SHALL BE PROVIDED WHERE NECESSARY TO INSTALL ELECTRICAL EQUIPMENT. WOOD MATERIALS SHALL BE TERMITE TREATED AND FIRE PROOFED, IRON OR STEEL MATERIALS SHALL BE GALVANIZED FOR CORROSION PROTECTION, NON-FERROUS MATERIALS SHALL BE BRASS OR BRONZE. ALL WOOD SCREWS SHALL BE BRASS OR GALVANIZED STEEL.

	EQUIPMENT SCHEDULE	
EQUIPMENT	MANUFACTURER OR APPROVED EQUAL	MODEL (CAT. #)
ARMORED CABLE, XLPE 1/C #6 AWG, 5kV (COPPER) 90 DEG C	SHAWCOR (SHAWFLEX PRODUCTS) LISTING: IEEE 383 & 1202, ICEA T-30-520	#8S210M060105700 MIN. BENDING RADIUS (15.8 INCHES)
NON-SHIELDED CABLE, XLPE 1/C #6 AWG 5kV (COPPER) 90 DEG C	PRIORITY WIRE LISTING: ICEA -S-66-524, NEMA-WC7	#P02O1
CABLE JUNCTION BOX MAX VOLTAGE: 6.6kV	THORNE & DERRICK INTERNATIONAL LISTING: IP66	MJB MOUNTING: WALL
MEDIUM VOLTAGE SWITCHGEAR 5.5kV, 200 AMPERES 600kV BIL, 12.5kA SHORT-TIME RATING	SQUARE D LISTING: UL	MINI-BREAK LOAD INTERRUPTER MOUNTING: WALL
5kV CABLE SPLICE KIT TYPE: ARMORED & NON-ARMORED CABLE RUBBER, IN-LINE	3M LISTING: IEEE 404	#5551-AC

3. EXECUTION

- A. SAFETY PRECAUTIONS SHALL BE TAKEN AT ALL TIMES TO PROTECT PERSONS, PROPERTY AND EQUIPMENT.
- B. RELOCATION OF ANY DEVICE WITHIN 10 FEET OF ITS INDICATED LOCATION BEFORE INSTALLATION SHALL BE DONE WITHOUT ADDITIONAL COST TO THE OWNER.
- C. EQUIPMENT AND FIXTURES SHALL BE PROPERLY CONNECTED WITH ADEQUATE POWER AND CHECKED THOROUGHLY FOR PROPER OPERATION.

HIGHWAY

DIST. NO.


STATE

- D. EXPOSED EQUIPMENT SHALL BE INSTALLED AS PER DRAWINGS AND IS SUBJECT TO ARCHITECTURAL INSPECTION FOR AESTHETIC APPEARANCE.
- E. PROJECT GROUNDING SYSTEM SHALL BE INSTALLED AS REQUIRED BY N.E.C. ARTICLE 250.
- F. CONTRACTOR SHALL DO ALL CUTTING AND PATCHING OF HIS WORK WHICH MAY BE REQUIRED TO RECEIVE THE WORK OF OTHER CONTRACTORS.
- G. MEGGER TEST PRIOR TO ENERGIZING FOR THE FIRST TIME, ALL PIECES OF ELECTRICAL EQUIPMENT TO ASSURE THEM TO HAVE PROPER PHASE-TO-PHASE AND PHASE-TO-GROUND INSTALLATION AND TO BE FREE OF GROUNDS AND SHORTS.
- H. THE ENTIRE SITE SHALL BE CLEANED OF MATERIALS, DEBRIS, TOOLS, AND EQUIPMENT RELATED TO THIS WORK DAILY. ALL ITEMS OF ELECTRICAL EQUIPMENT ON JOB SITE SHALL BE KEPT PROTECTED AND COVERED AT ALL TIMES.
- I. WARRANTY:
 - 1) INSTALLATION SHALL BE COMPLETE IN EVERY DETAIL AND READY TO USE.
 - 2) UNLESS OTHERWISE STATED, THE WARRANTY STARTS ON THE DATE WRITTEN NOTICE FROM THE CONTRACTOR IS GIVEN AND IS ACCEPTED BY THE OWNER STATING THE PROJECT IS COMPLETE AND ALL REQUIRED CORRECTIONS HAVE BEEN MADE. THE WARRANTY SHALL CERTIFY THAT ALL DEFECTS IN MATERIAL OR WORKMANSHIP SHALL BE PROMPTLY REPAIRED OR REPLACED BY THE CONTRACTOR, TO THE SATISFACTION OF THE OWNER, FOR A PERIOD OF ONE (1) YEAR.

DEMOLITION NOTES:

- 1. THE DEMOLITION DRAWINGS ARE INTENDED TO SHOW THE GENERAL SCOPE OF WORK AND DO NOT NECESSARILY SHOW EVERY DEVICE, BOX, CONDUIT, ETC. TO BE REMOVED. THE CONTRACTOR SHALL FIELD VERIFY OTHER ELECTRICAL SERVICES THAT MAY BE ENCOUNTERED DURING DEMOLITION AND SHALL REMOVE OR REROUTE THESE ITEMS AS DIRECTED.
- 2. MAINTAIN CIRCUIT CONTINUITY AS REQUIRED FOR FIXTURES AND DEVICES INDICATED TO REMAIN, INCLUDING THOSE OUTSIDE OF PROJECT LIMITS.

 COORDINATE WITH NEW WORK AND RE-ROUTE CONDUIT AND WIRE AS REQUIRED TO AVOID CONFLICT WITH NEW WORK.
- 3. ALL REMAINING JUNCTION AND PULL BOXES SHALL BE ACCESSIBLE AS PER NATIONAL ELECTRICAL CODE (N.E.C.). THE CONTRACTOR SHALL MOVE EXISTING BOXES, ETC. AS REQUIRED BY NEW CONSTRUCTION.
- 4. ALL MATERIALS REMOVED REMAIN THE PROPERTY OF THE OWNER IF THE OWNER CHOOSES TO DISCARD THESE MATERIALS THEN THE CONTRACTOR SHALL DISPOSE OF THEM AS DIRECTED.

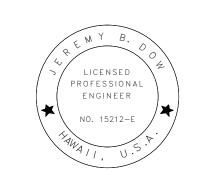

THIS WORK WAS PREPARED BY ME OR UNDER MY SUPERVISION.

4-30-24

EXPIRATION DATE OF THE LICENSE

STATE OF HAWAI'I
DEPARTMENT OF TRANSPORTATION
HIGHWAYS DIVISION

FISCAL SHEET

NO.

E2

YEAR

2022

HIGHWAY

PROJ. NO.

HWY-OT-SMP-01

TOTAL

SHEETS

ELECTRICAL NOTES AND

SPECIFICATIONS

LIKELIKE HIGHWAY

WILSON TUNNEL ELECTRICAL

IMPROVEMENTS


HWY-OT-SMP-01

Scale: N.T.S.

SHEET No. E2 OF 19 SHEETS


TRACED BY
DESIGNED BY
QUANTITIES BY
CHECKED BY
CHECKED BY
Sers\zacharv cowan\Documents\220255 \text{Wilson Tunnel F B21}

HIGHWAY DIST. NO.	STATE	HIGHWAY PROJ. NO.	FISCAL YEAR	SHEET NO.	TOTAL SHEETS	
HAWAII	HAW.	HWY-OT-SMP-01	2022	E3	19	

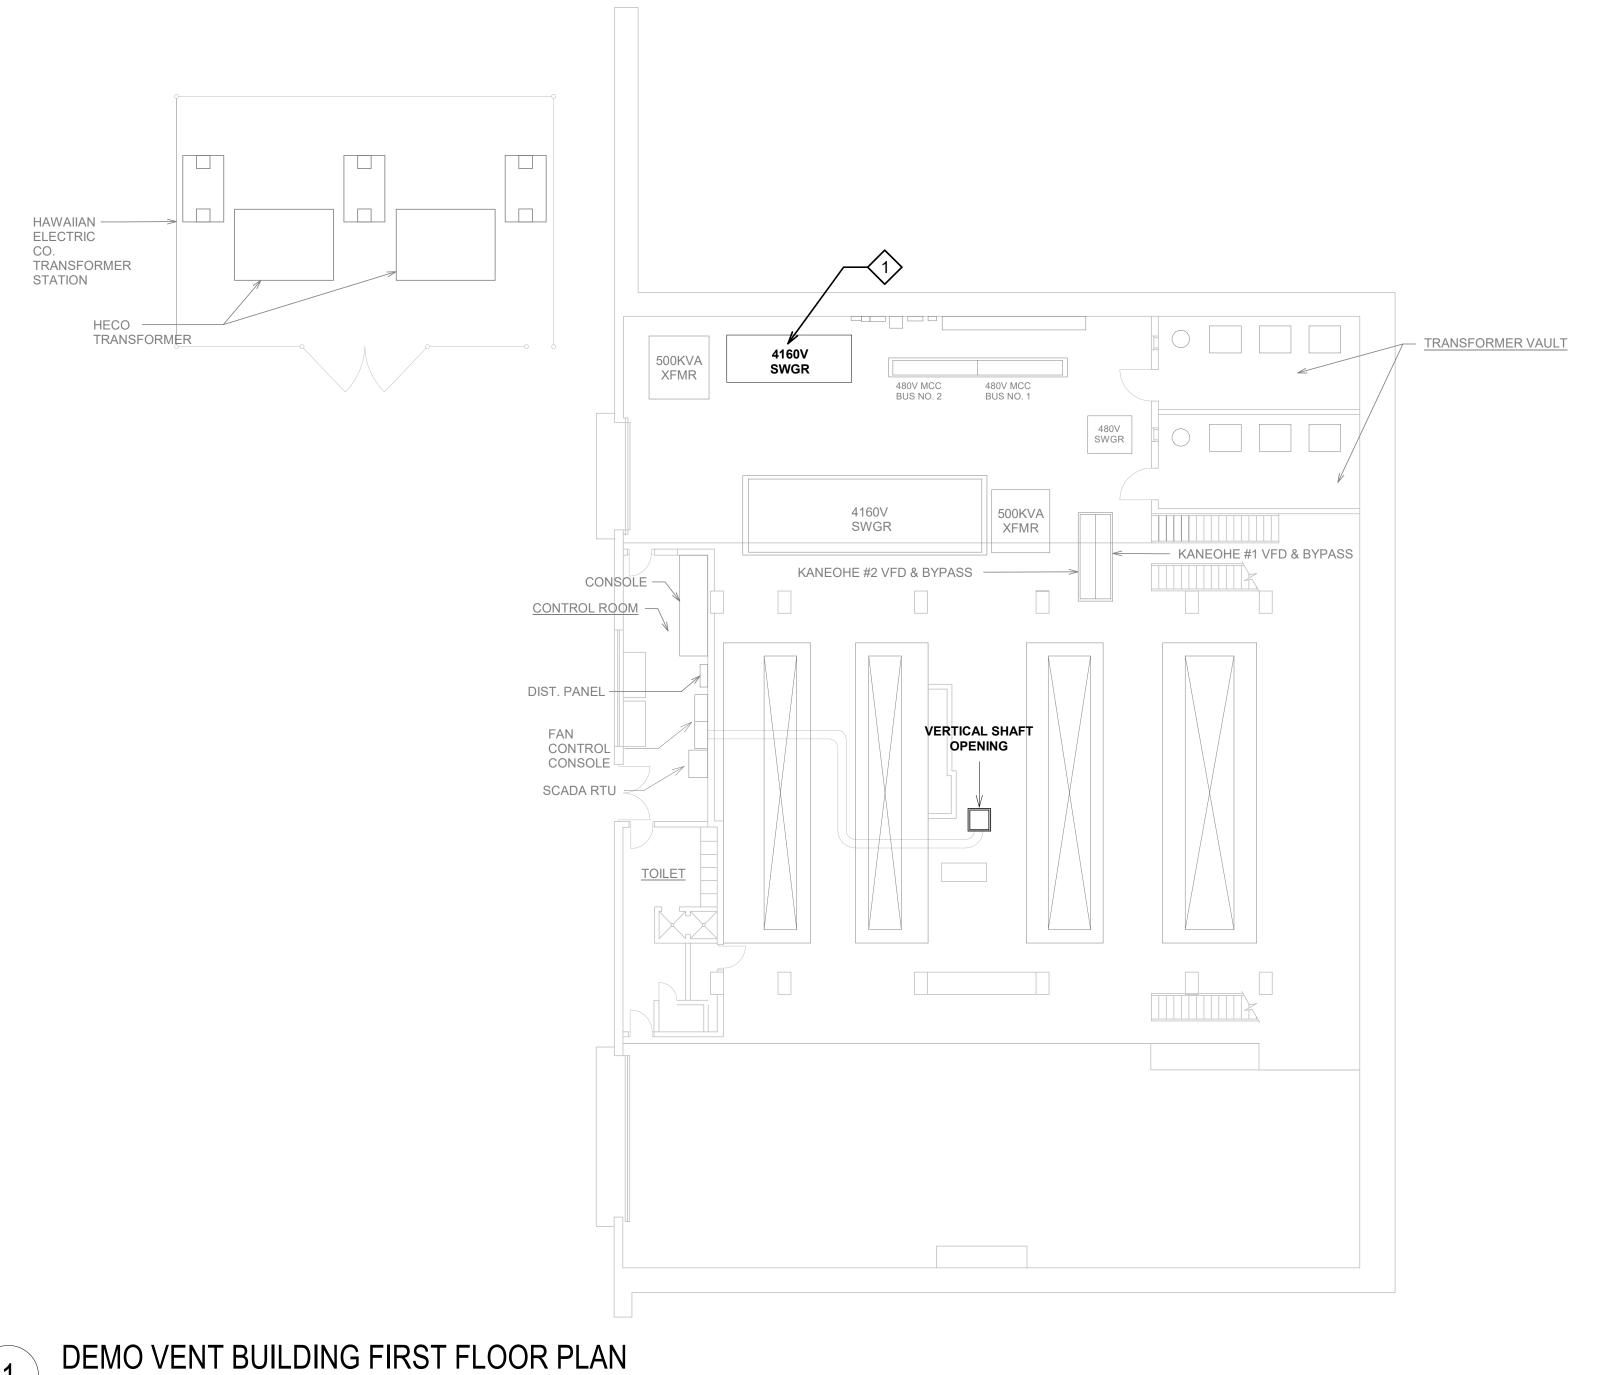



THE MV CABLE TO BE REPLACED ORIGINATES AT THIS SWITCHGEAR. REUSE EXISTING BREAKERS AT EITHER END OF THE SWITCHGEAR.

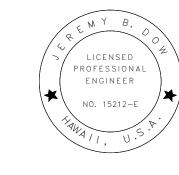

THIS WORK WAS PREPARED BY ME OR UNDER MY SUPERVISION.

STATE OF HAWAI'I DEPARTMENT OF TRANSPORTATION HIGHWAYS DIVISION


DEMO VENT BUILDING FIRST FLOOR PLAN LIKELIKE HIGHWAY
WILSON TUNNEL ELECTRICAL
IMPROVEMENTS HWY-OT-SMP-01

Scale: 1/16" = 1'-0"

OF 19 SHEETS SHEET No. E3



HIGHWAY DIST. NO.	STATE	HIGHWAY PROJ. NO.	FISCAL YEAR	SHEET NO.	TOTAL SHEETS
HAWAII	HAW.	HWY-OT-SMP-01	2022	E4	19

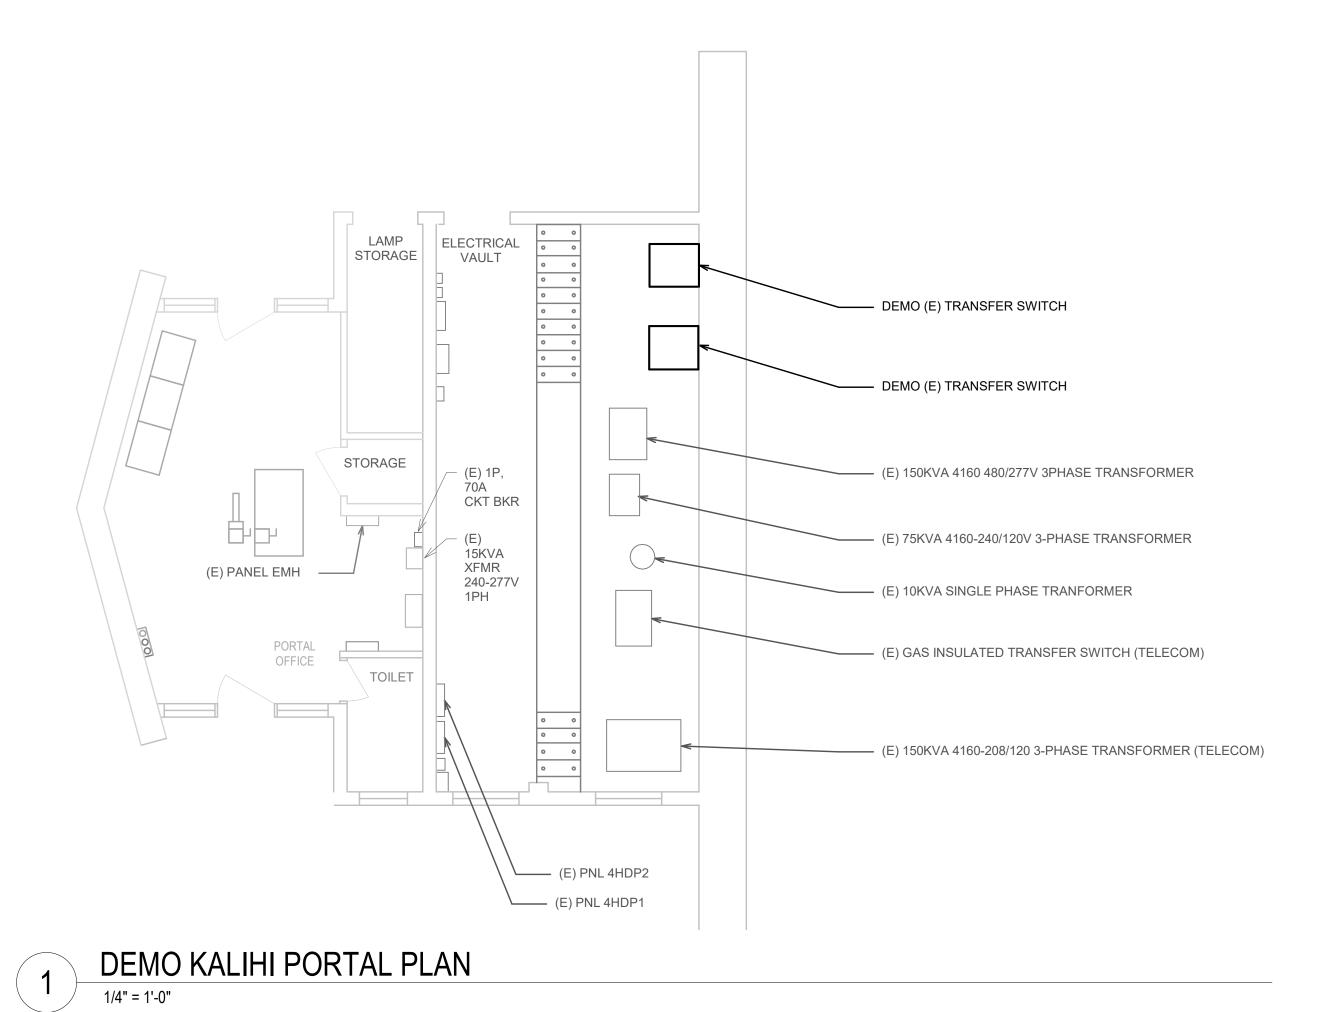

LICENSED
PROFESSIONAL
ENGINEER
NO. 15212-E

TANA / I, U.S.

THIS WORK WAS PREPARED BY ME OR UNDER MY SUPERVISION.

STATE OF HAWAI'I DEPARTMENT OF TRANSPORTATION HIGHWAYS DIVISION

DEMO KALIHI PORTAL PLAN

LIKELIKE HIGHWAY
WILSON TUNNEL ELECTRICAL
IMPROVEMENTS
HWY-OT-SMP-01

Scale: 1/4" = 1'-0" Dat

SHEET No. E4 OF 19 SHEETS

 ORIGINAL
 SURVEY PLOTTED BY
 DATE


 PLAN
 DRAWN BY
 "

 OTE BOOK
 DESIGNED BY
 "

 QUANTITIES BY
 "


 CHECKED BY
 "

HIGHWAY DIST. NO.	STATE	HIGHWAY PROJ. NO.	FISCAL YEAR	SHEET NO.	TOTAL SHEETS
HAWAII	HAW.	HWY-OT-SMP-01	2022	E 5	19

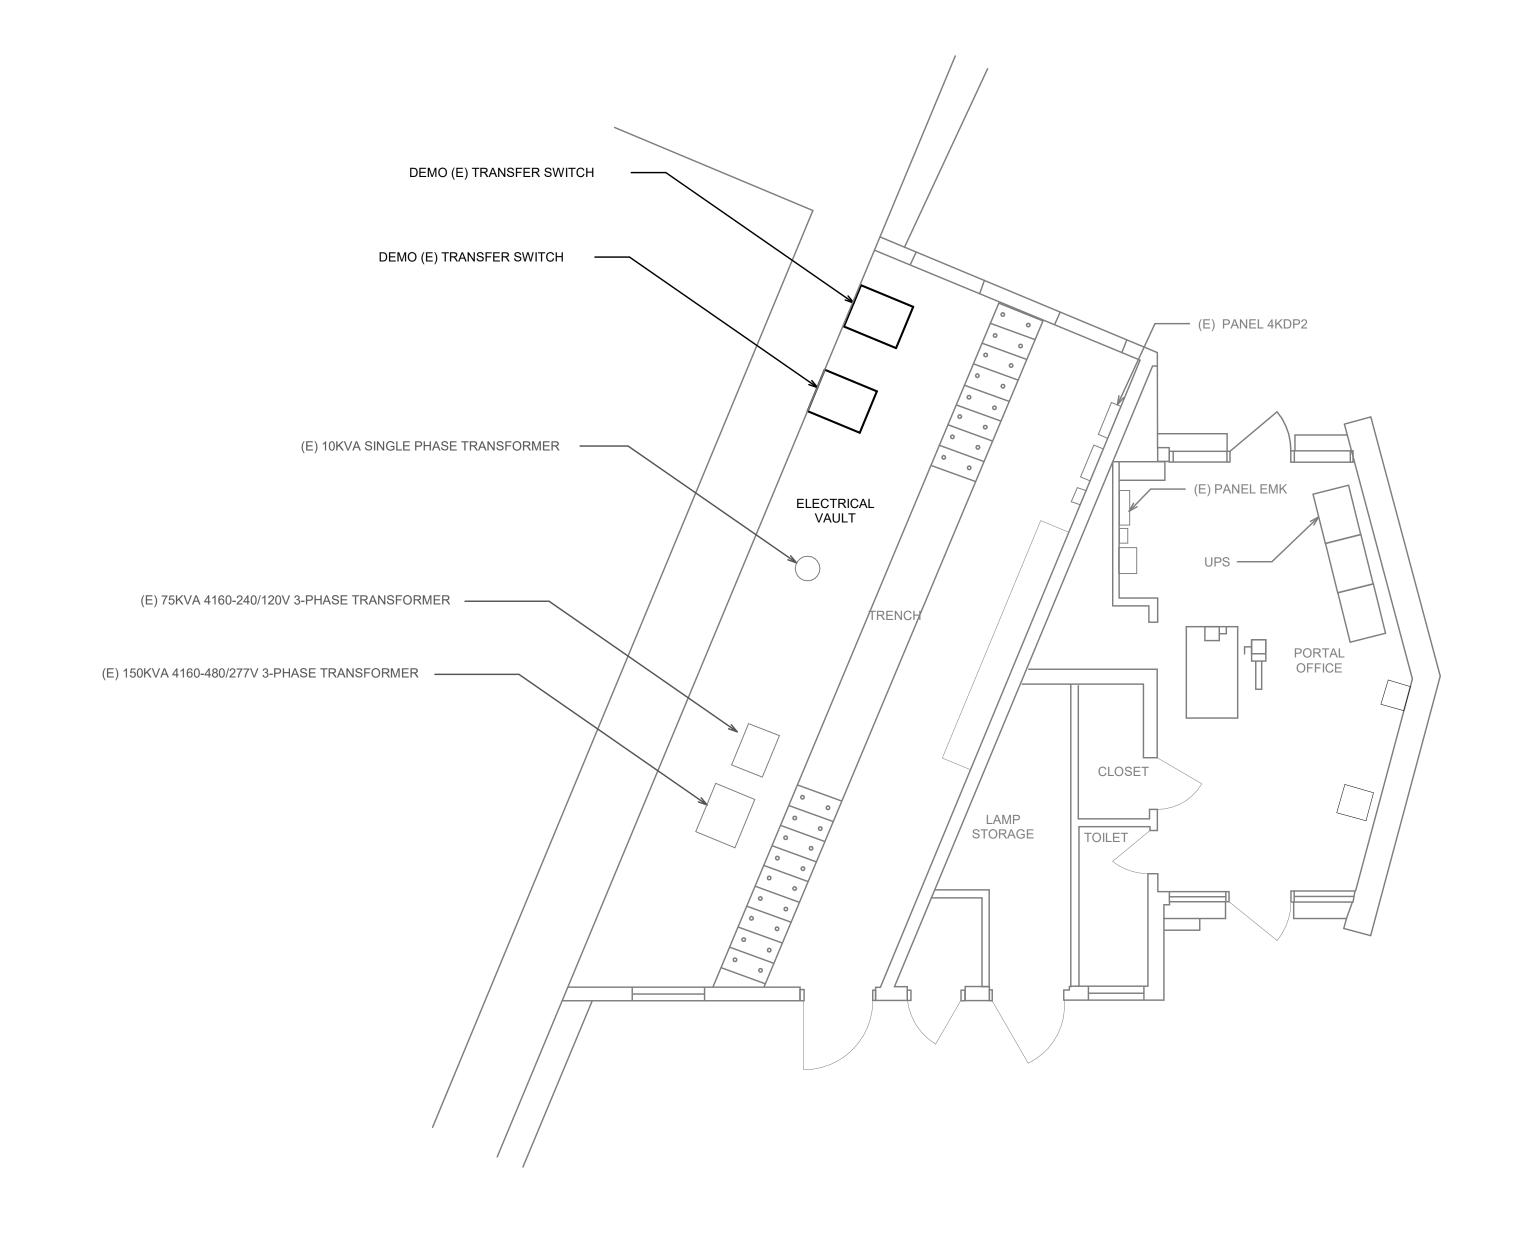

1 DEMO KANEOHE PORTAL PLAN

1/4" = 1'-0"

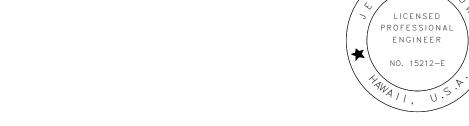

THIS WORK WAS PREPARED BY ME OR UNDER MY SUPERVISION.

4-30-24

SIGNATURE EXPRATION DATE OF THE LICENSE


STATE OF HAWAI'I DEPARTMENT OF TRANSPORTATION HIGHWAYS DIVISION

DEMO KANEOHE PORTAL
PLAN
LIKELIKE HIGHWAY
WILSON TUNNEL ELECTRICAL
IMPROVEMENTS
HWY-OT-SMP-01

Scale: 1/4" = 1'-0" Date

SHEET No. E5 OF 19 SHEETS

1/4" =1'-0" 0 1' 2' 3' 4' 6' 8' 1

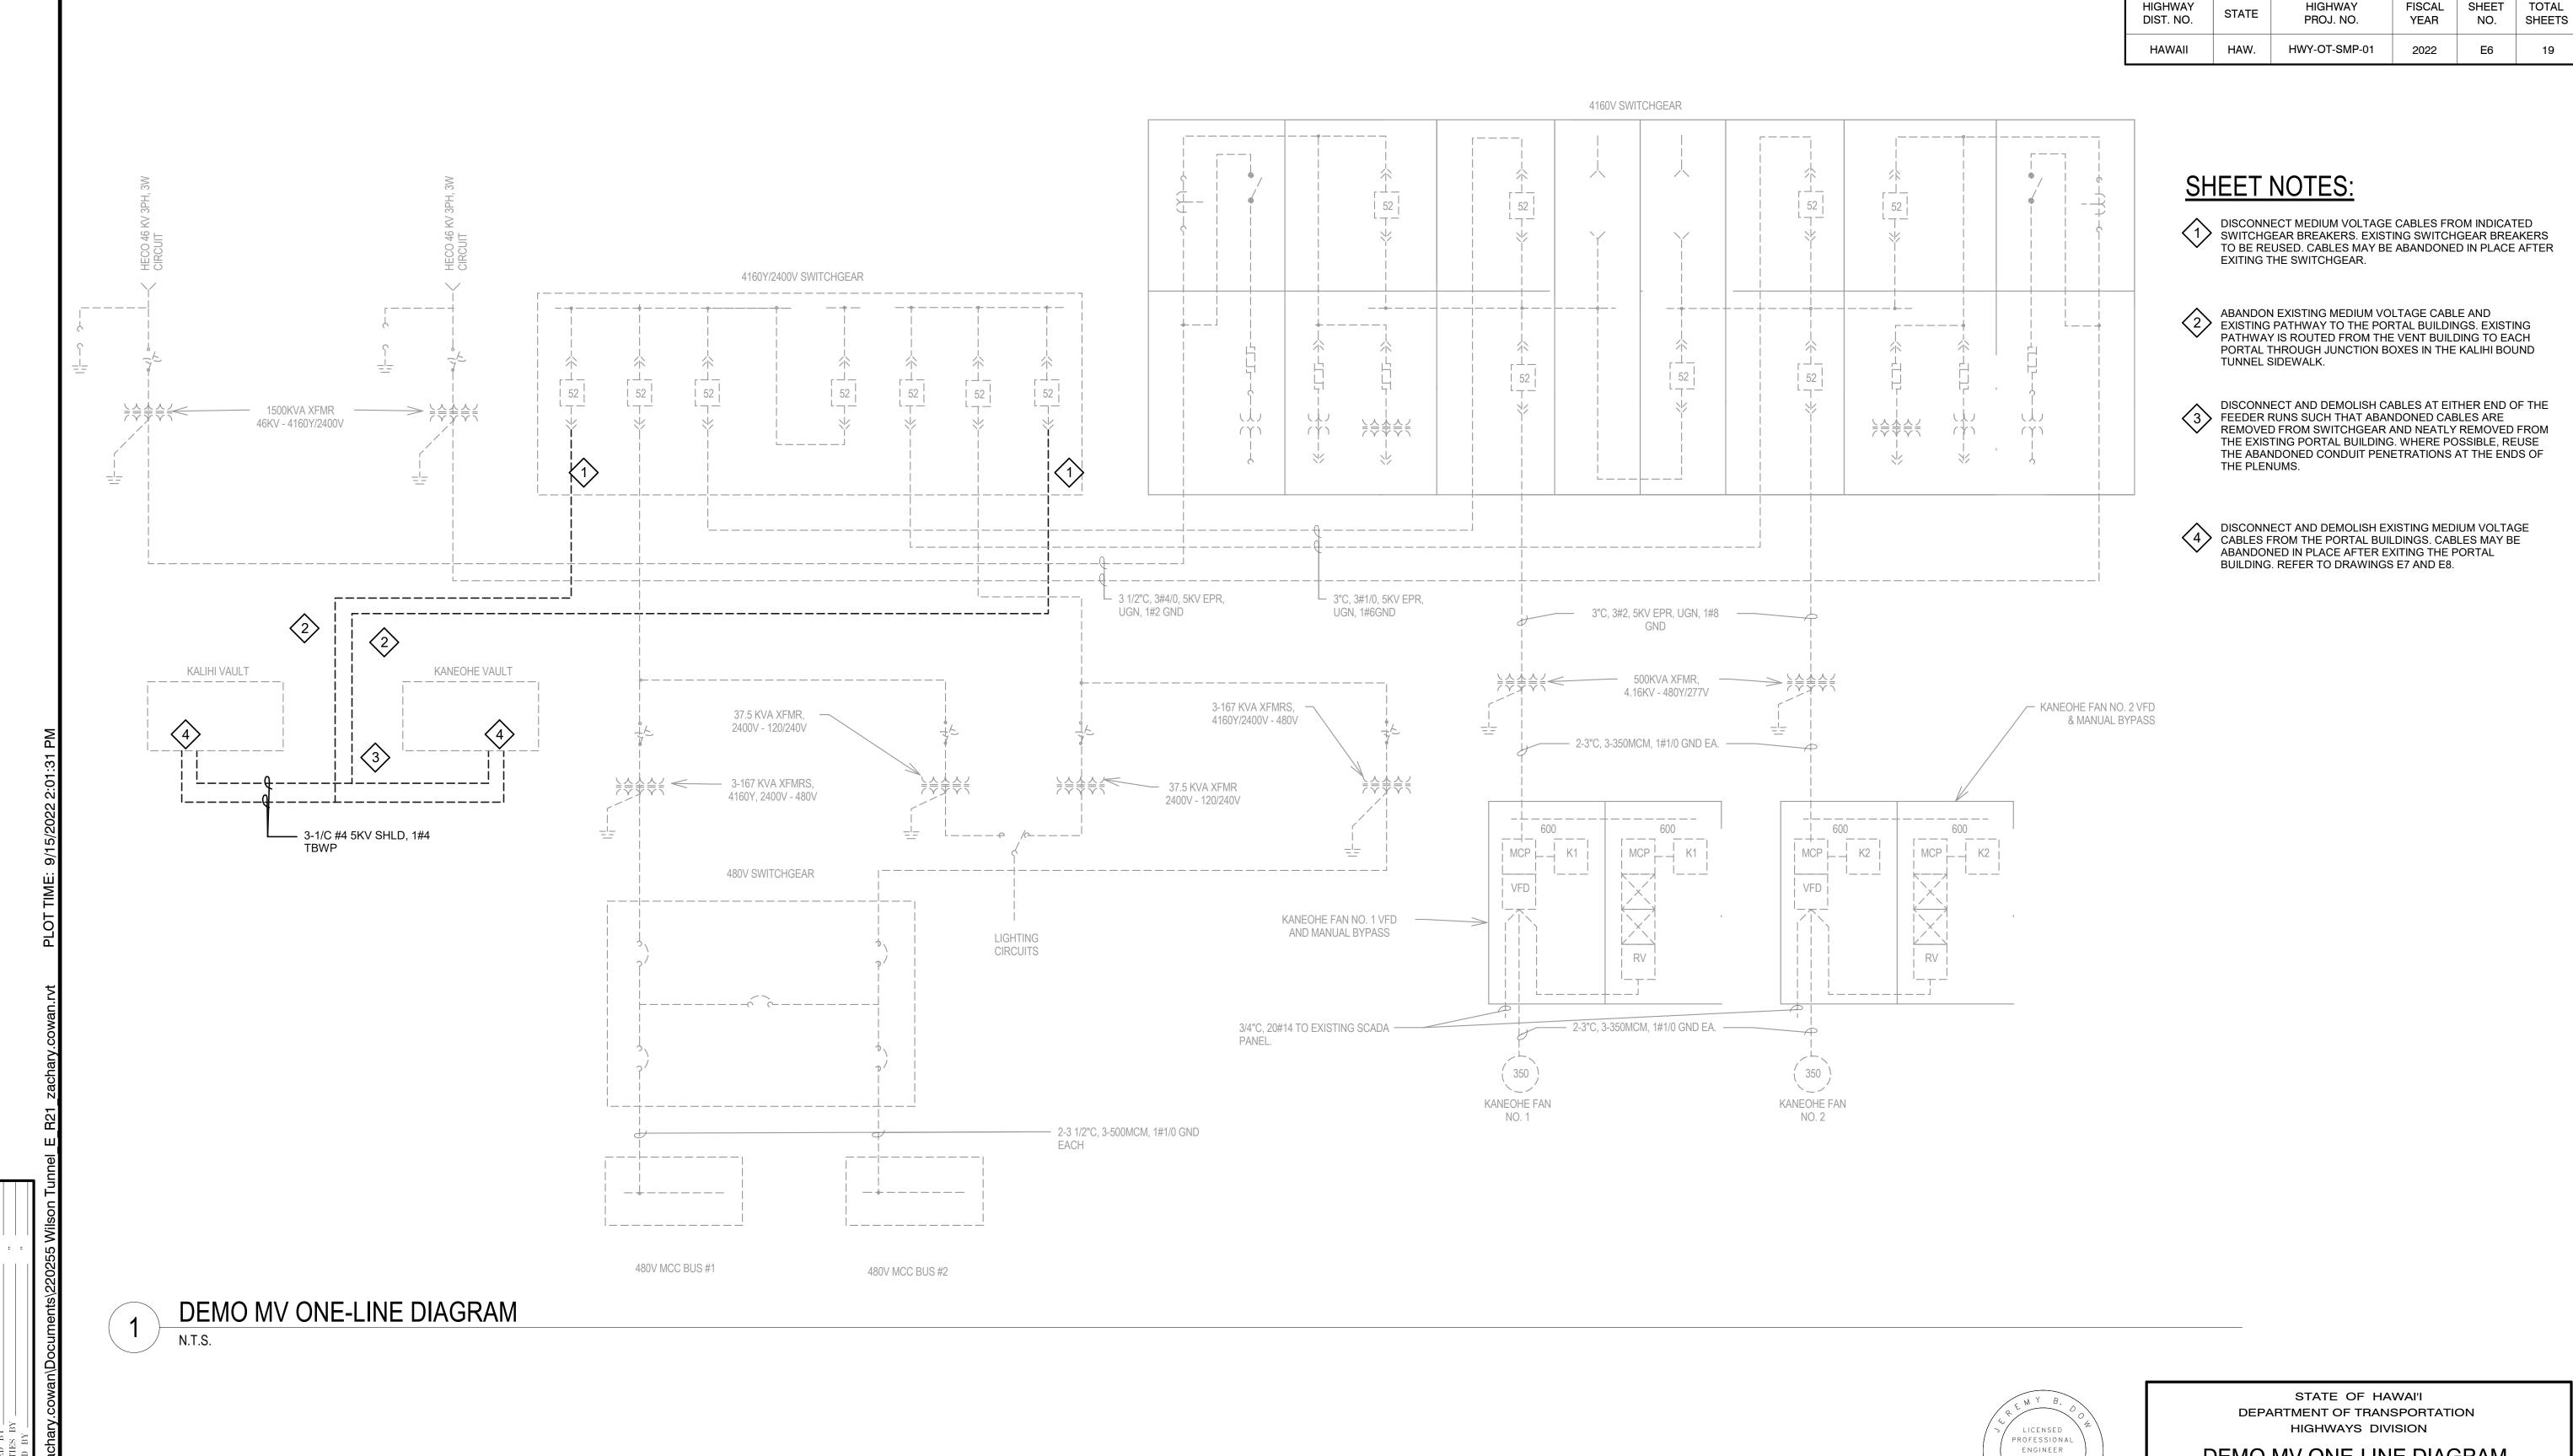


THIS WORK WAS PREPARED BY ME OR UNDER MY SUPERVISION.


DEMO MV ONE-LINE DIAGRAM


LIKELIKE HIGHWAY WILSON TUNNEL ELECTRICAL **IMPROVEMENTS** HWY-OT-SMP-01

Scale: N.T.S.

SHEET No. E6 OF 19 SHEETS

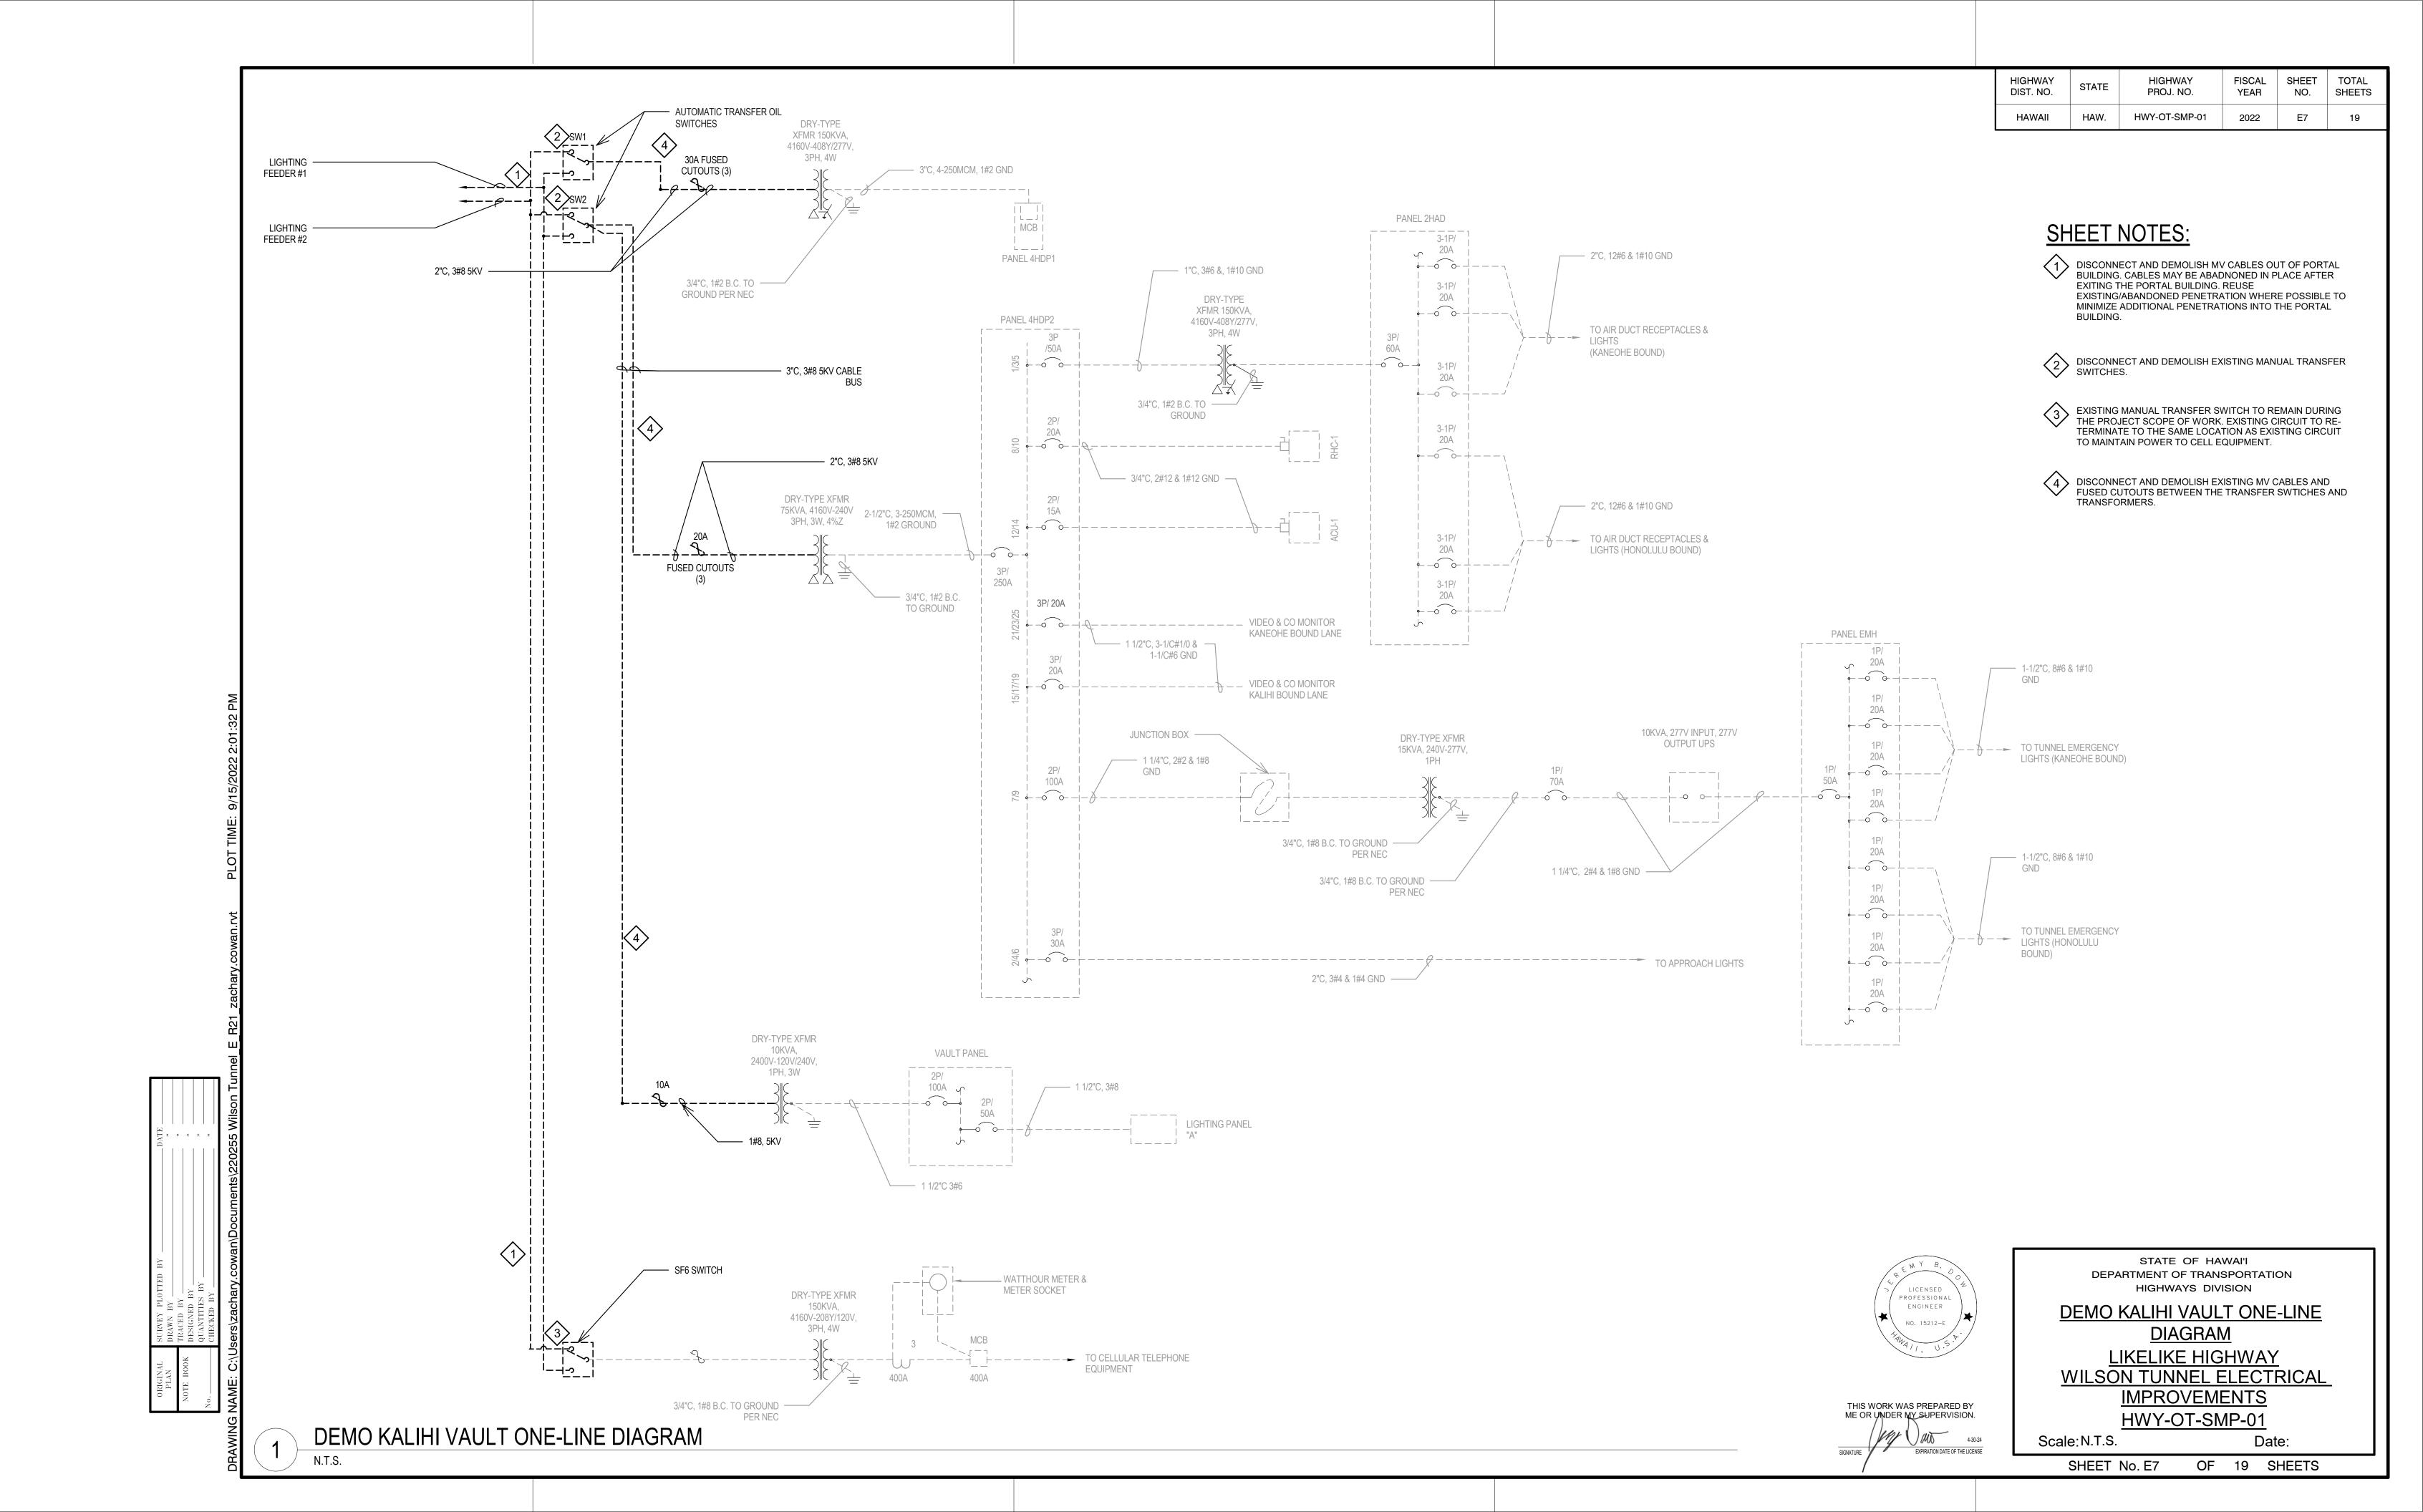

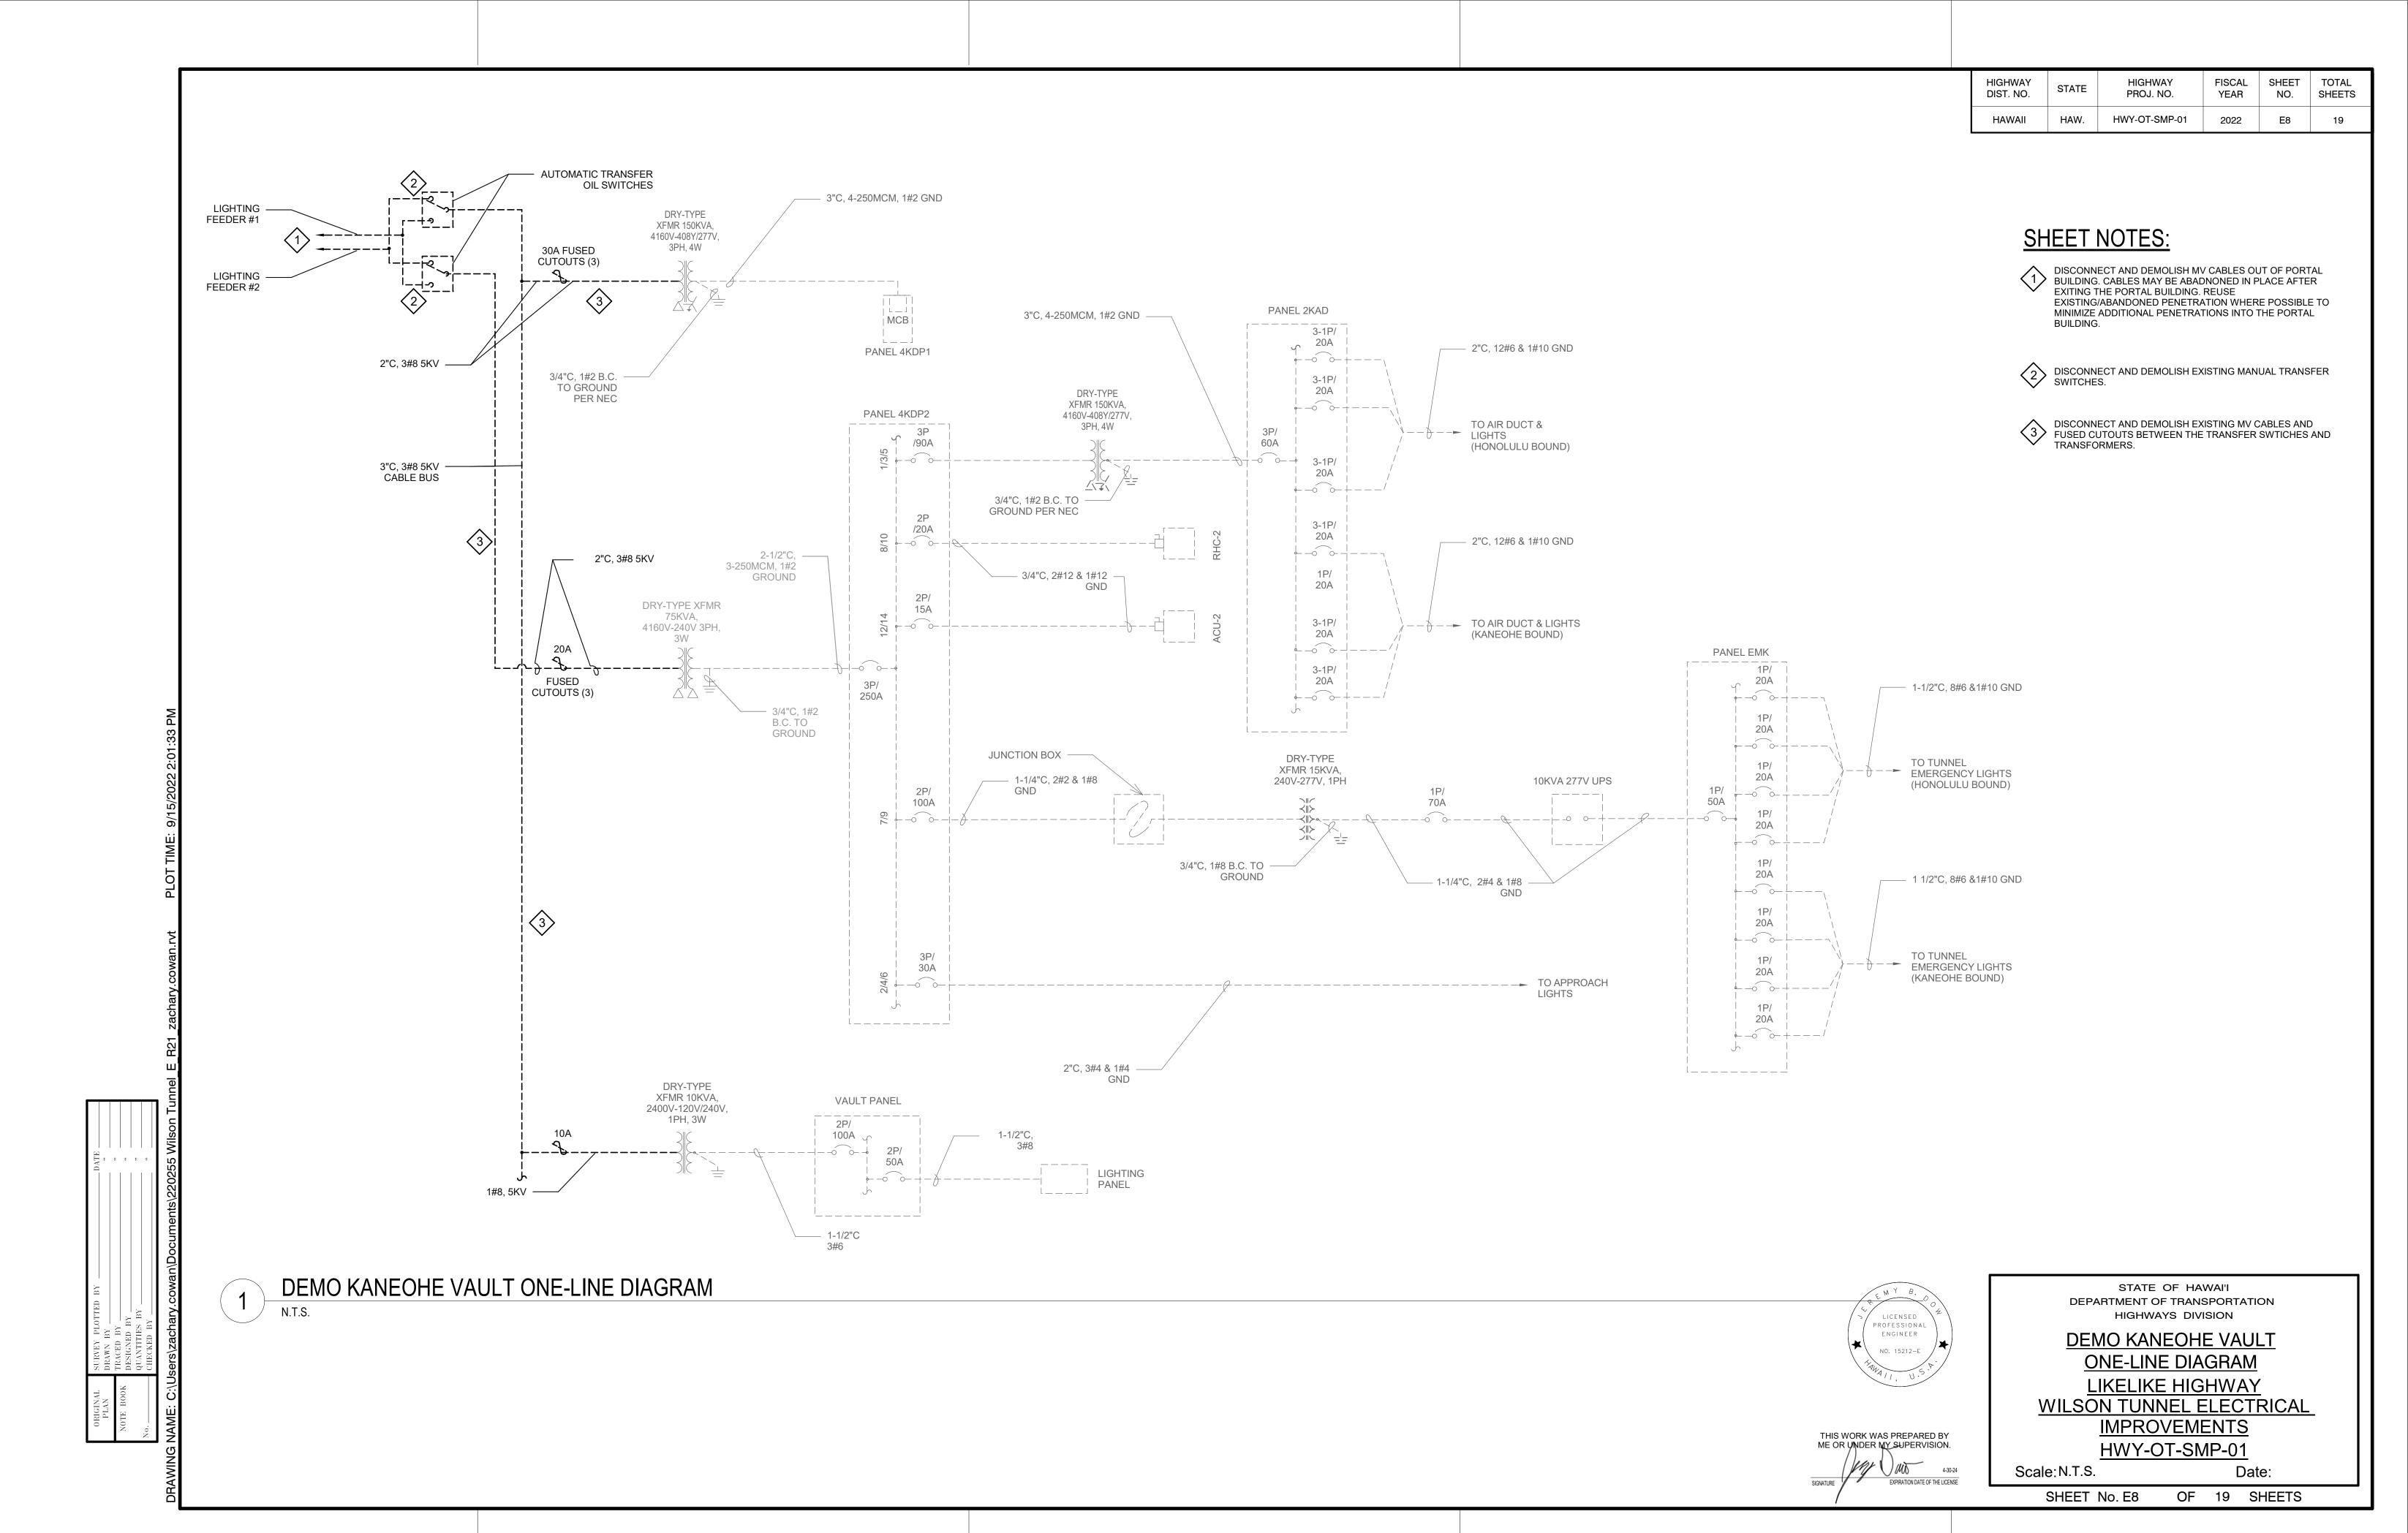

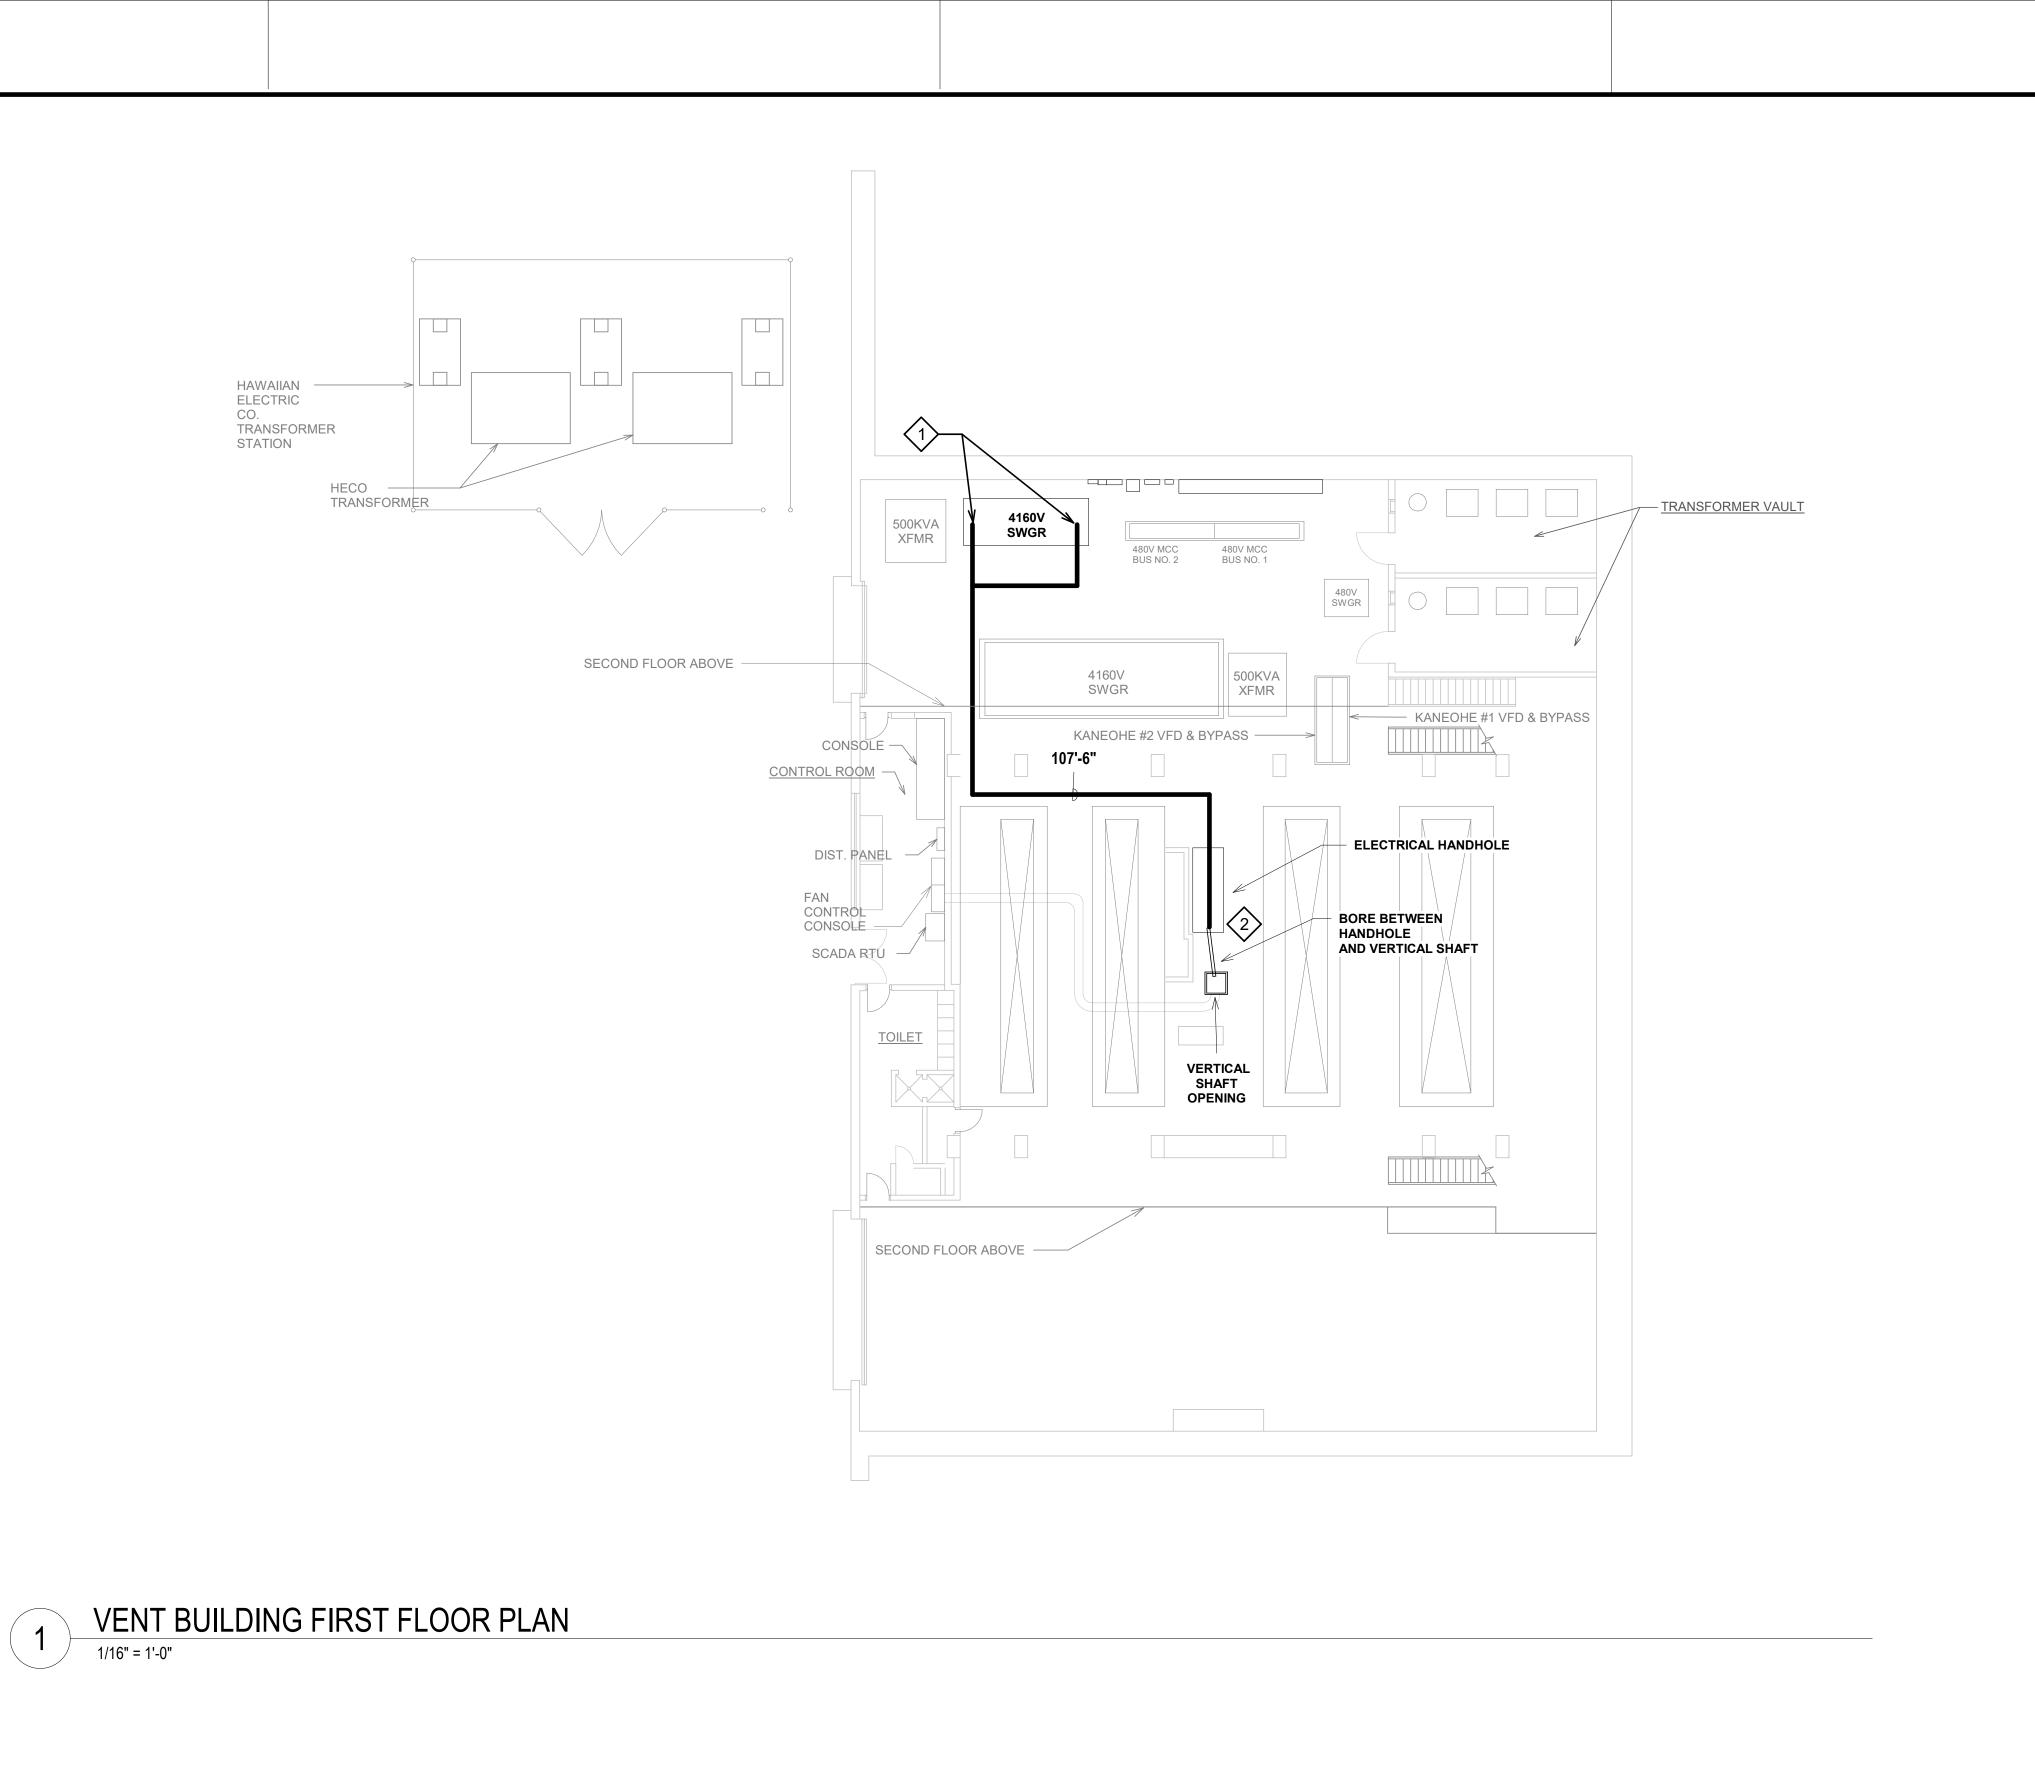



CONNECT MEDIUM VOLTAGE CABLES TO EXISTING BREAKERS IN EXISTING SWITCHGEAR. PROVIDE NEW CABLE TRAY FROM TOP OF SWITCHGEAR TO THE VENT BUILDING VERTICAL SHAFT. SECURE CABLE

SPLICE CONDUCTORS INTO ARMORED CABLE IN HANDHOLE WITH APPROVED SPLICE KIT.CONDUIT ROUTE DOWN TO VENTILATION SHAFT, SEE SHEET E12.

3 OBSERVE BENDING RADIUS OF ARMORED CABLE AS PER MANUFACTURER'S REQUIREMENTS.

TRAY TO THE UNDERSIDE OF THE SECOND FLOOR.

LICENSED PROFESSIONAL ENGINEER
NO. 15212-E

STATE OF HAWAI'I DEPARTMENT OF TRANSPORTATION HIGHWAYS DIVISION

VENT BUILDING FIRST FLOOR
PLAN
LIKELIKE HIGHWAY

LIKELIKE HIGHWAY
WILSON TUNNEL ELECTRICAL
IMPROVEMENTS
HWY-OT-SMP-01

 Scale: 1/16" = 1'-0"
 Date:

 SHEET No. E9
 OF 19 SHEETS

THIS WORK WAS PREPARED BY ME OR UNDER MY SUPERVISION.

4-30-24

SIGNATURE EXPIRATION DATE OF THE LICENSE

NOTE BOOK DESIGNED BY

NO. CHGINAL SURVEI PLOTIED BY

TRACED BY


QUANTITIES BY

CHECKED BY

CHECKED BY

1/16" =1'-0" 0 4' 8' 12' 16' 24' 32' 48'

HIGHWAY DIST. NO.	STATE	HIGHWAY PROJ. NO.	FISCAL YEAR	SHEET NO.	TOTAL SHEETS
HAWAII	HAW.	HWY-OT-SMP-01	2022	E10	19

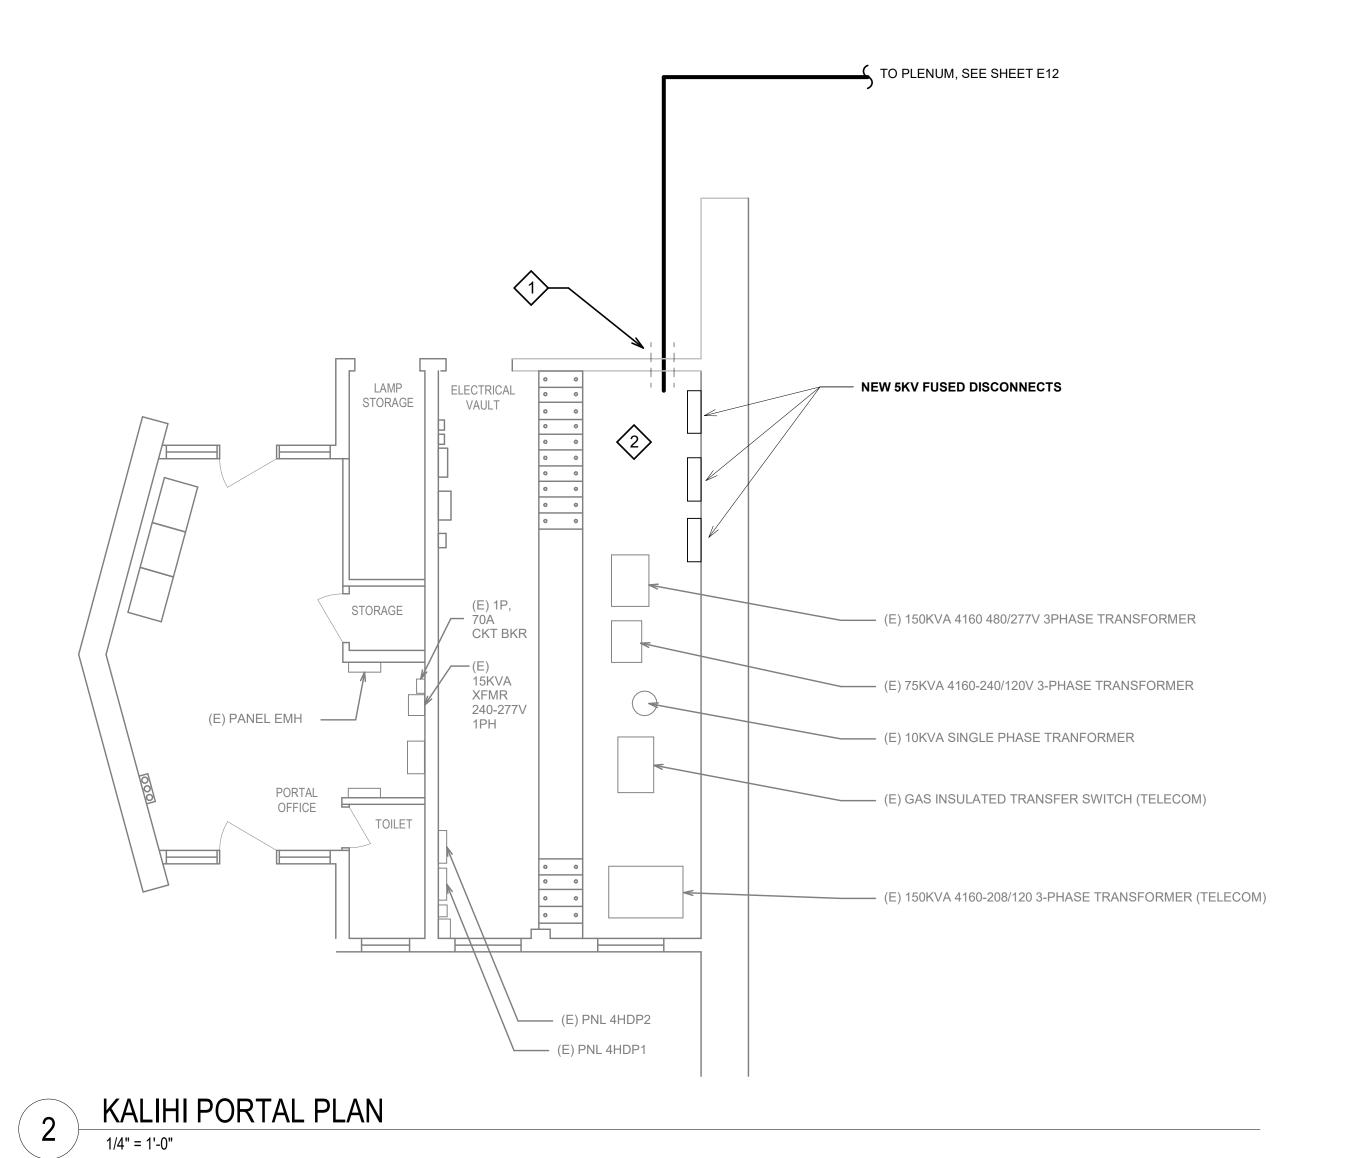

SCAN FOR REBAR, CORE DRILL, AND SLEEVE INTO PORTAL BUILDING.

REFER TO ONE-LINE DIAGRAM FOR NEW CONNECTIONS, SEE SHEET E17.



THIS WORK WAS PREPARED BY ME OR UNDER MY SUPERVISION.

STATE OF HAWAI'I DEPARTMENT OF TRANSPORTATION HIGHWAYS DIVISION

KALIHI PORTAL PLAN

LIKELIKE HIGHWAY
WILSON TUNNEL ELECTRICAL
IMPROVEMENTS HWY-OT-SMP-01

OF 19 SHEETS

Scale: 1/4" = 1'-0"

SHEET No. E10

HIGHWAY DIST. NO.	STATE	HIGHWAY PROJ. NO.	FISCAL YEAR	SHEET NO.	TOTAL SHEETS
HAWAII	HAW.	HWY-OT-SMP-01	2022	E11	19



SCAN FOR REBAR, CORE DRILL, AND SLEEVE INTO PORTAL BUILDING.

REFER TO ONE-LINE DIAGRAM FOR NEW CONNECTIONS, SEE SHEET E18.

THIS WORK WAS PREPARED BY ME OR UNDER MY SUPERVISION.

STATE OF HAWAI'I DEPARTMENT OF TRANSPORTATION HIGHWAYS DIVISION


KANEOHE PORTAL PLAN

LIKELIKE HIGHWAY
WILSON TUNNEL ELECTRICAL
IMPROVEMENTS HWY-OT-SMP-01

Scale: 1/4" = 1'-0"

SHEET No. E11 OF 19 SHEETS



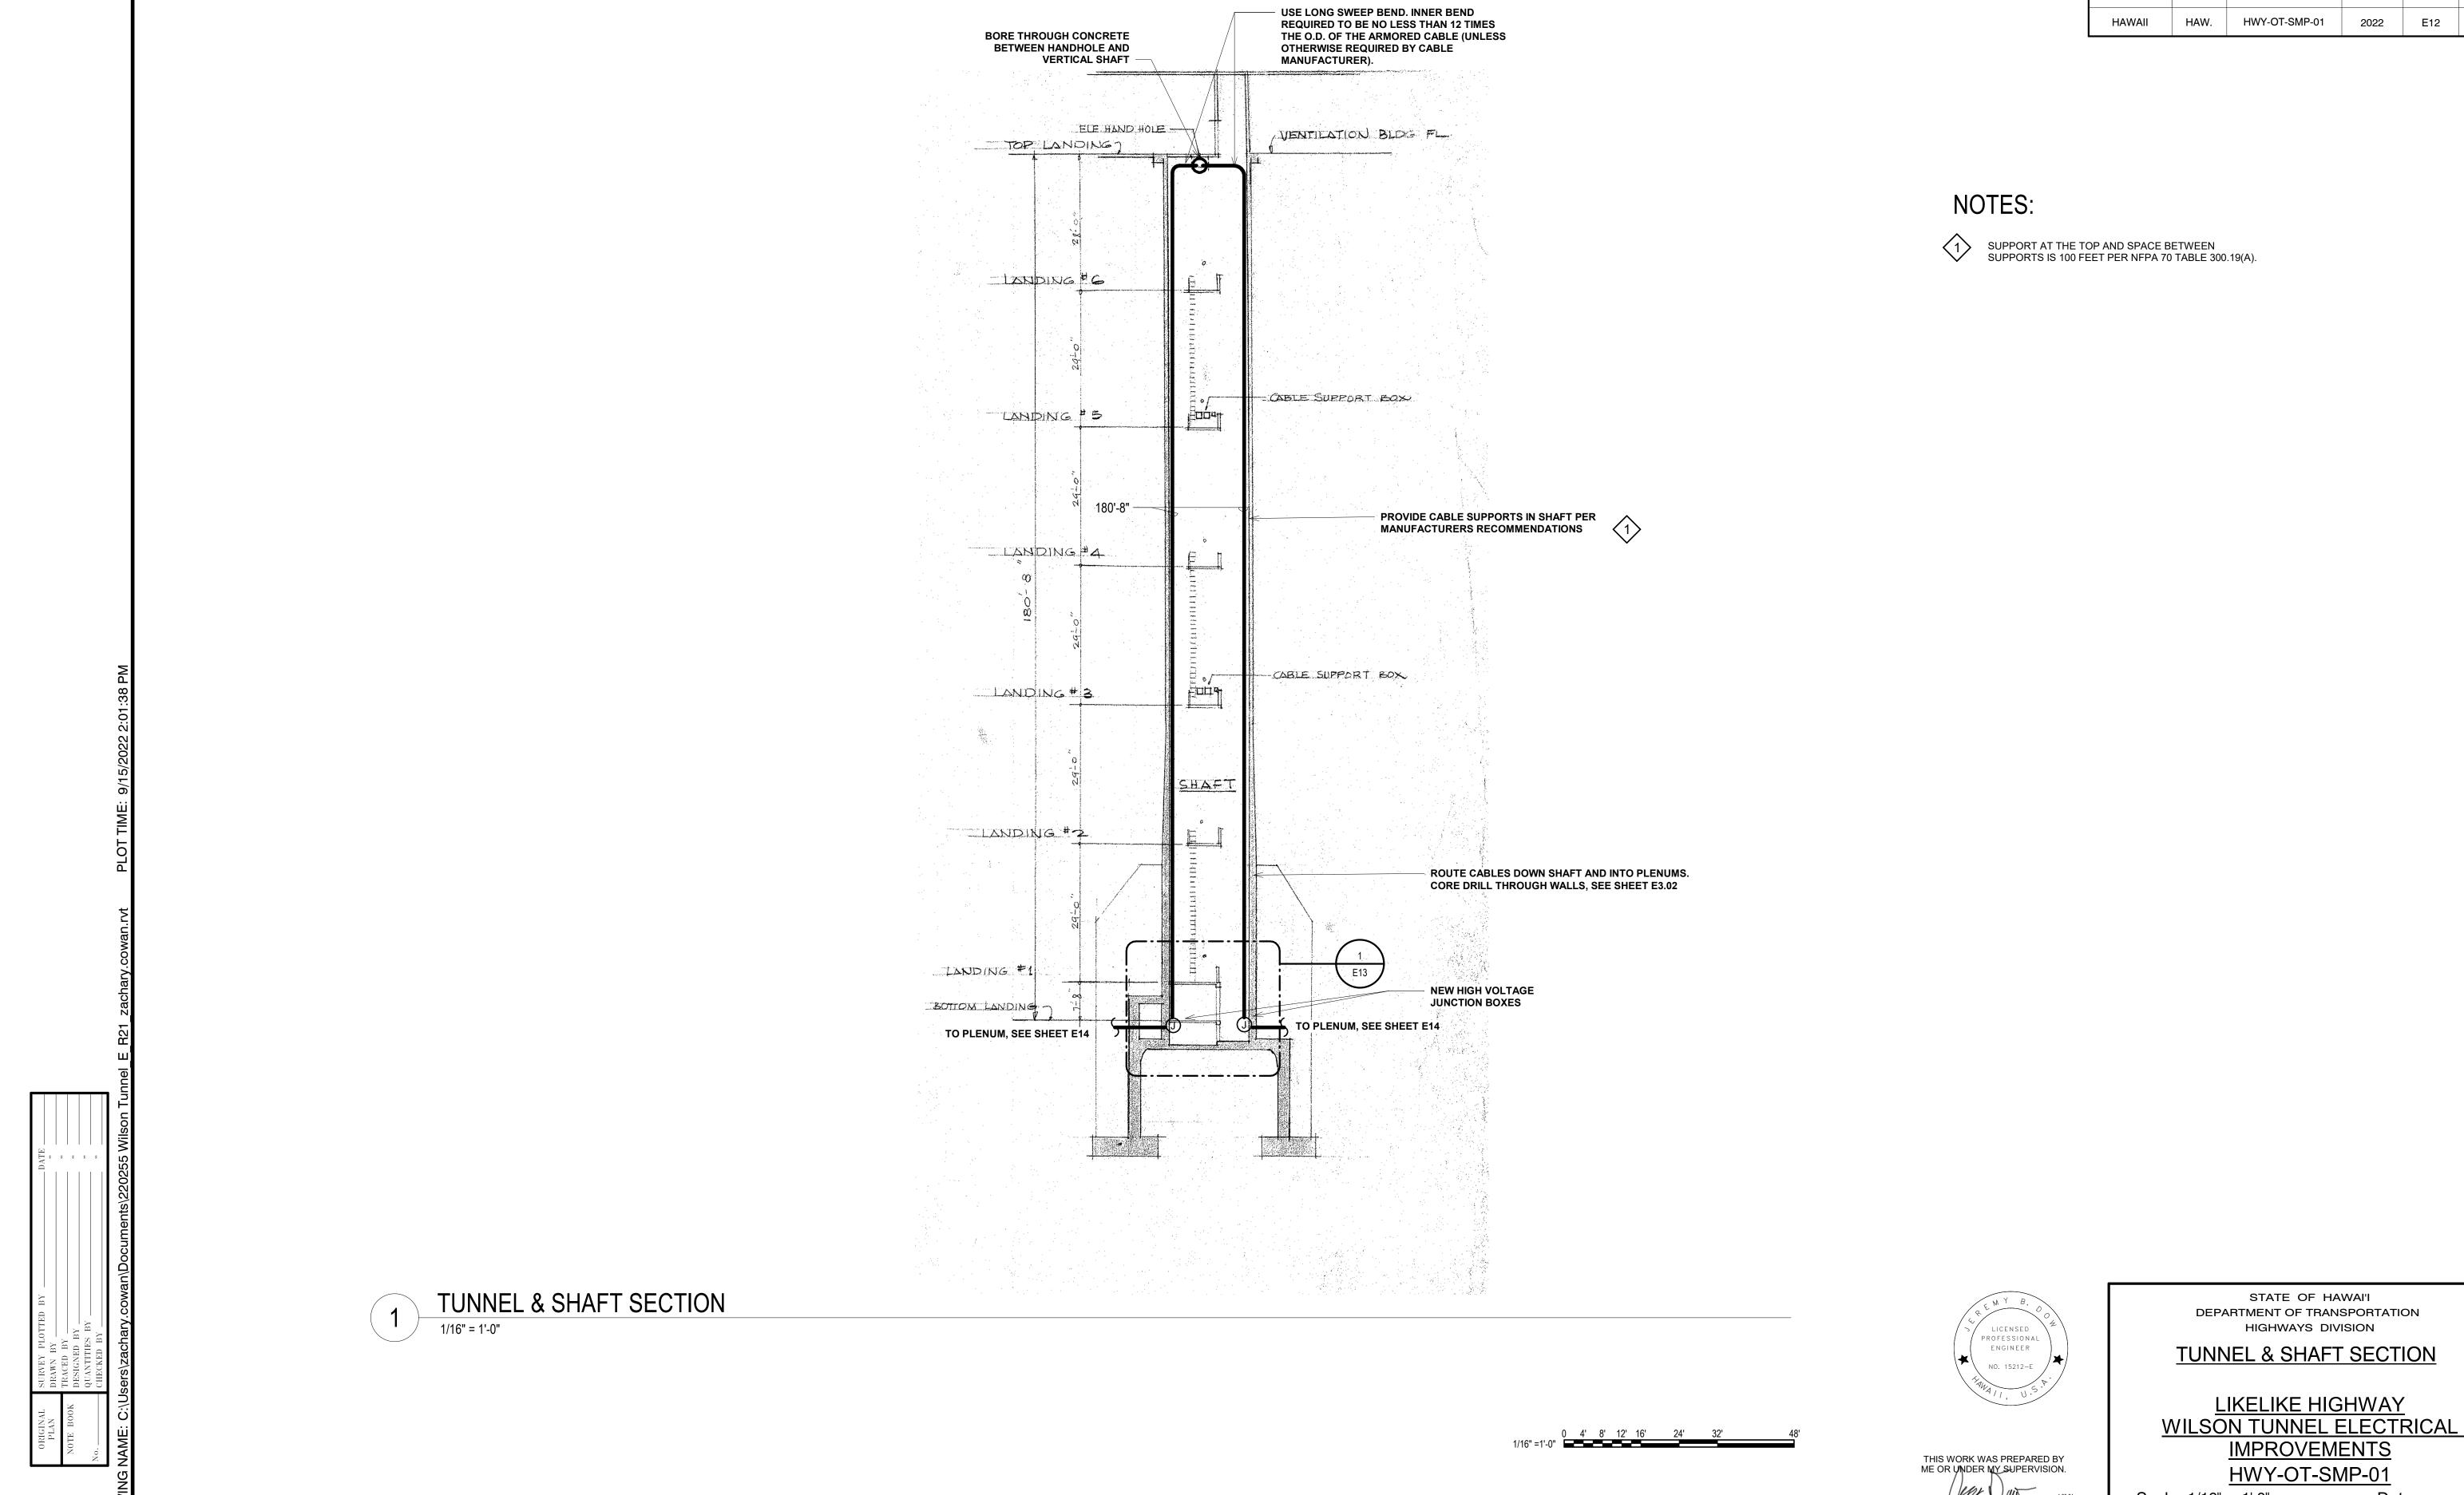


HIGHWAY DIST. NO. FISCAL SHEET TOTAL YEAR NO. SHEETS HIGHWAY STATE NO. SHEETS PROJ. NO.


Scale: 1/16" = 1'-0"

SHEET No. E12 OF 19 SHEETS

HIGHWAY DIST. NO.	STATE	HIGHWAY PROJ. NO.	FISCAL YEAR	SHEET NO.	TOTAL SHEETS
HAWAII	HAW.	HWY-OT-SMP-01	2022	E13	19

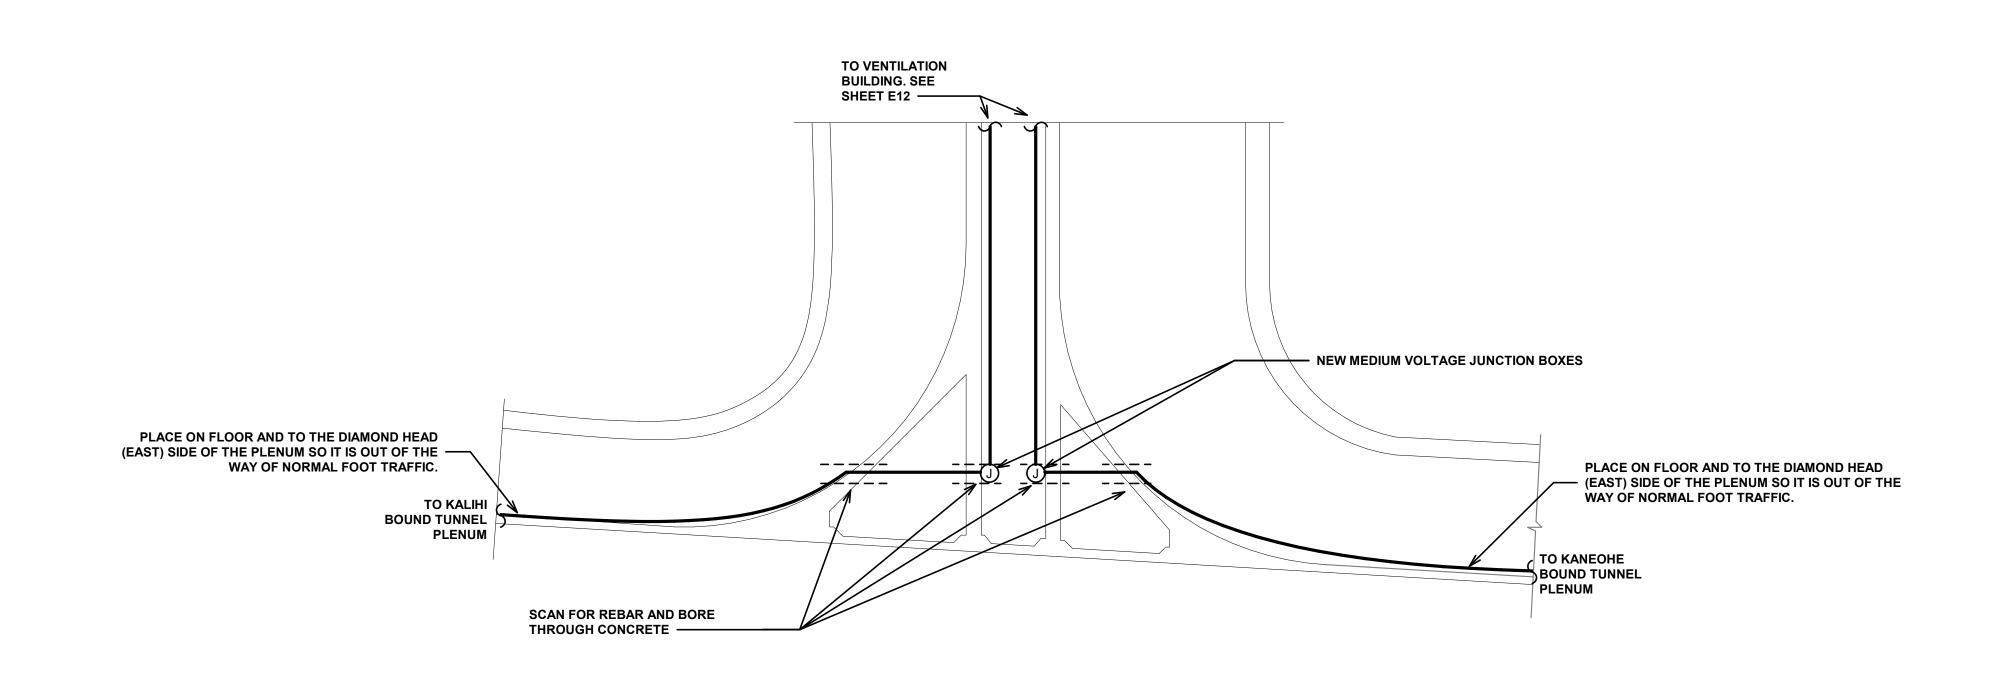

1 VENTILATION SHAFT/AIR PLENUM SECTION N.T.S.

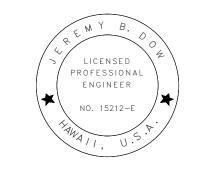

THIS WORK WAS PREPARED BY ME OR UNDER MY SUPERVISION.


STATE OF HAWAI'I
DEPARTMENT OF TRANSPORTATION
HIGHWAYS DIVISION

VENTILATION SHAFT/AIR
PLENUM SECTION
LIKELIKE HIGHWAY
WILSON TUNNEL ELECTRICAL
IMPROVEMENTS
HWY-OT-SMP-01

Scale: N.T.S. Date

SHEET No. E13 OF 19 SHEETS

	F	"	.,	
DIVERSIA DI	TRACED BY	ESIGNED BY	QUANTITIES BY	ED BY

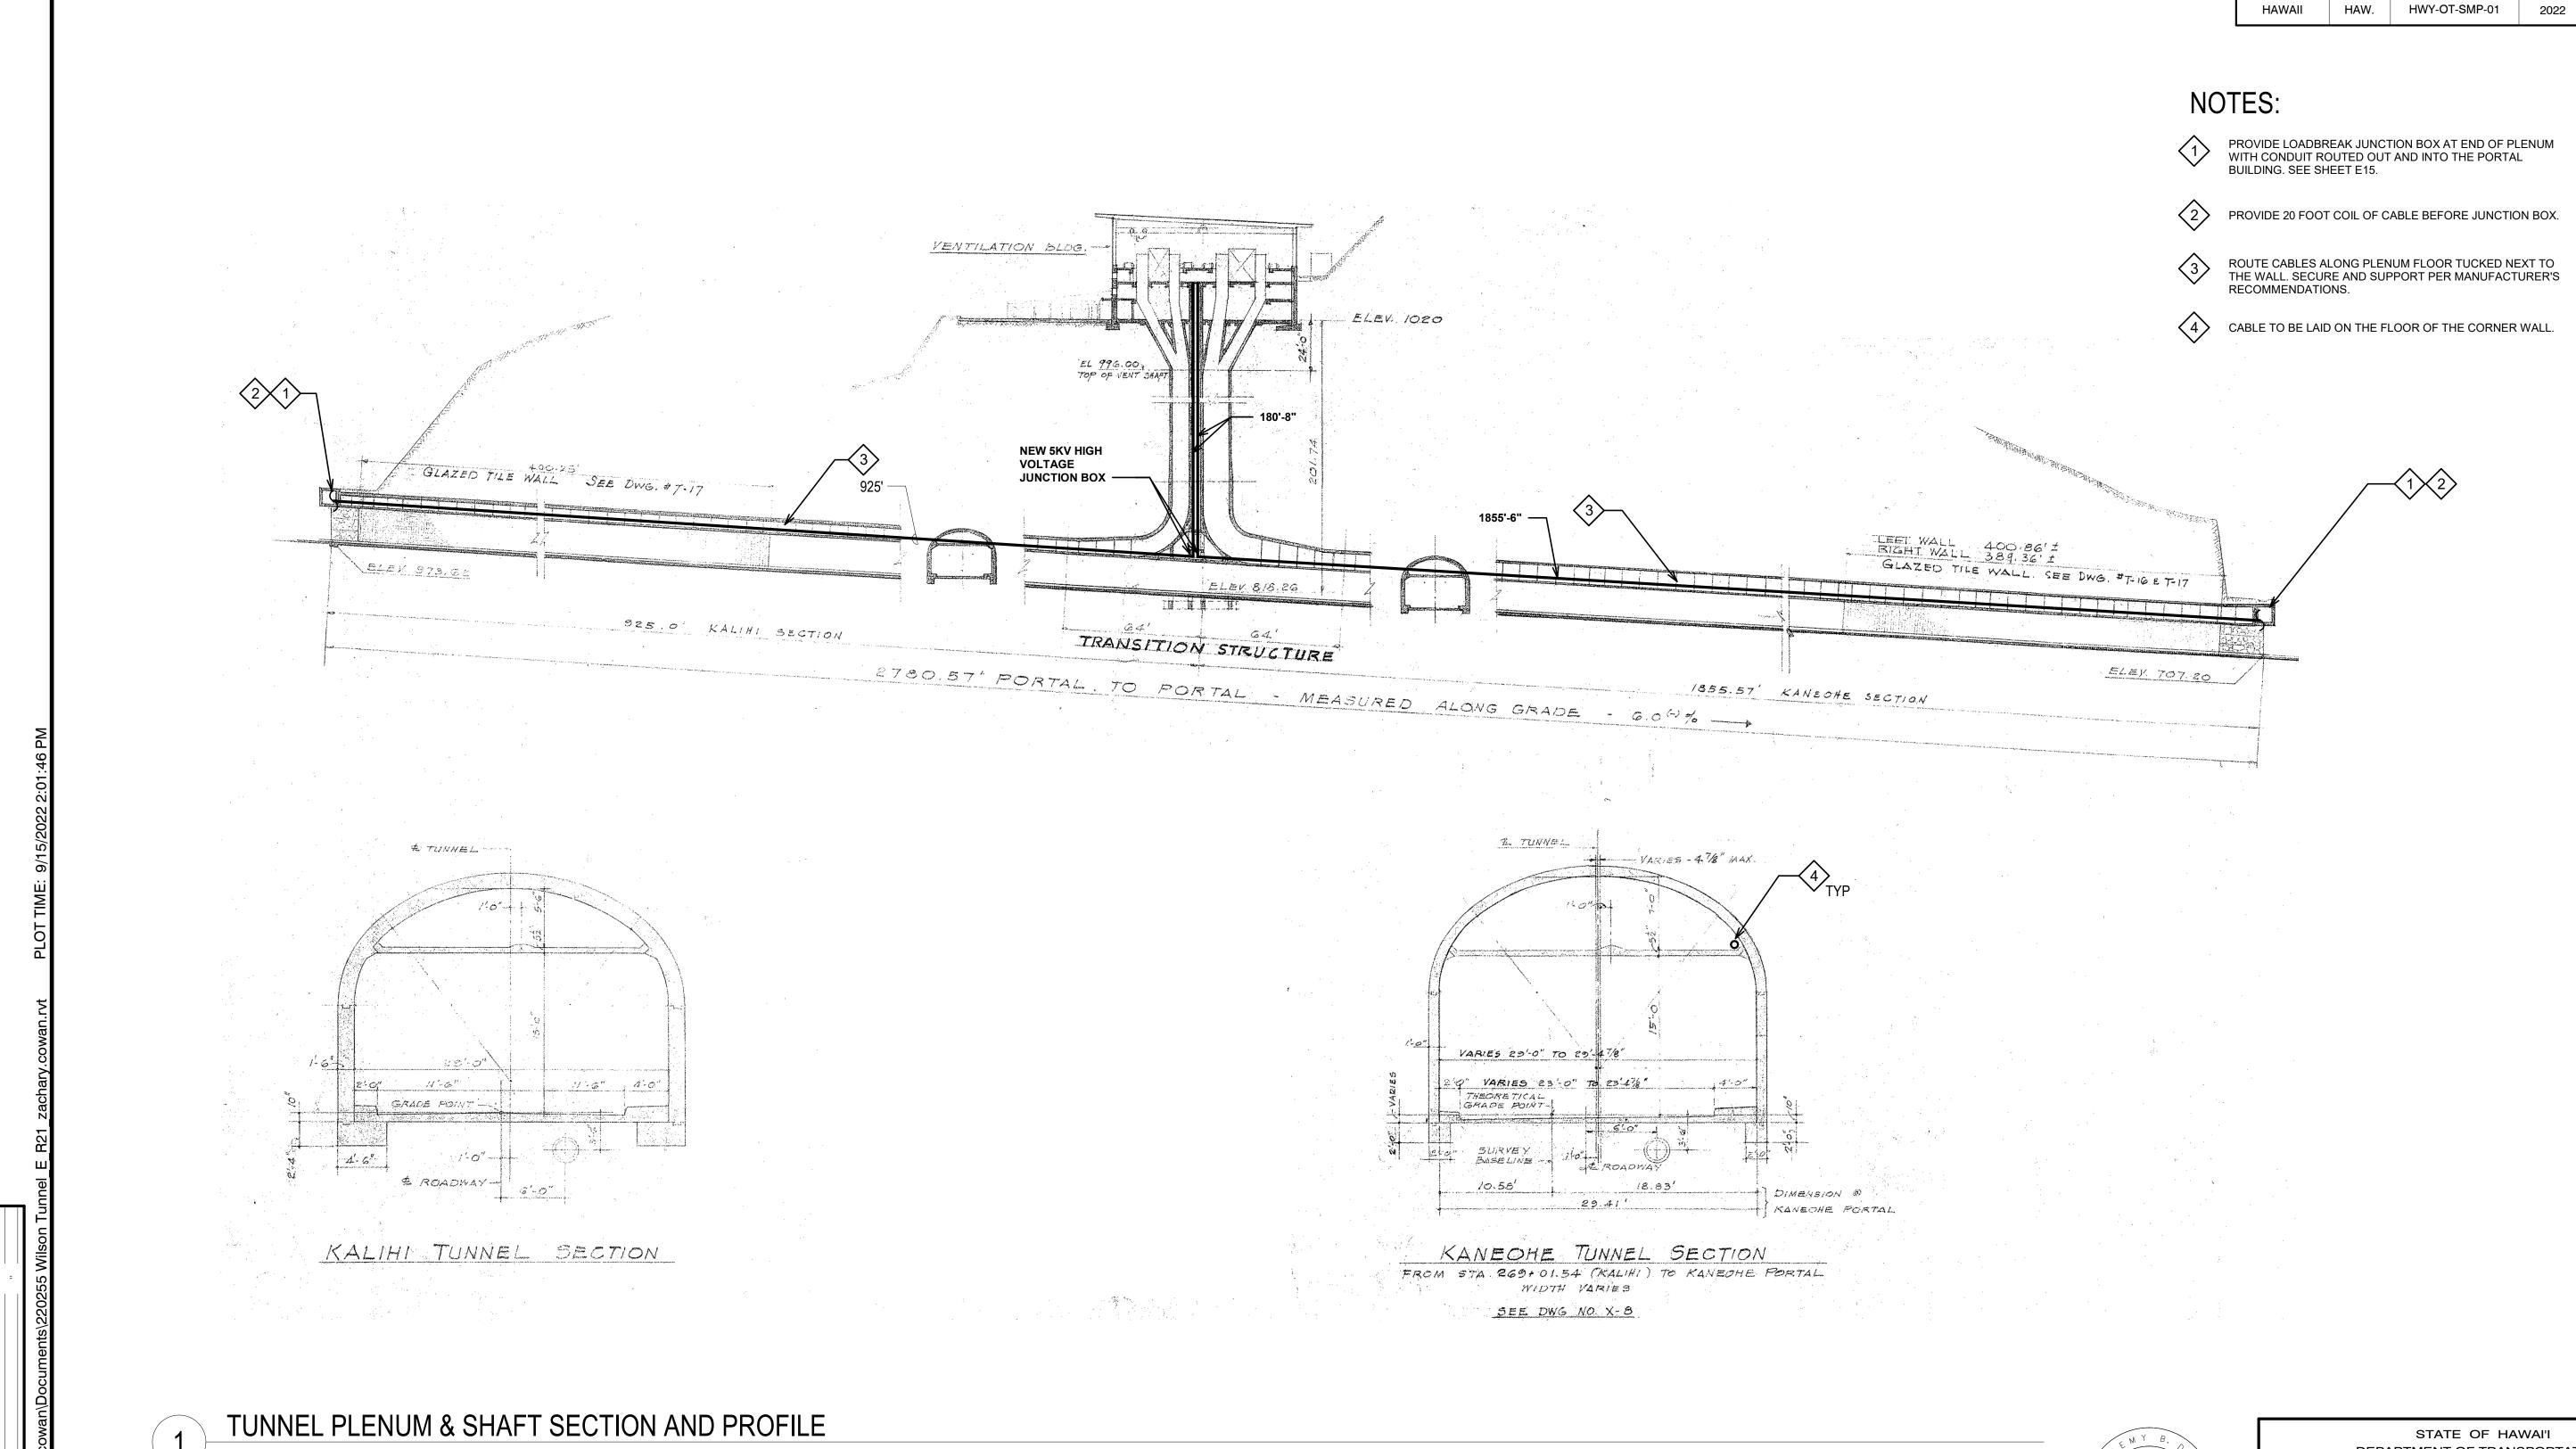

STATE OF HAWAI'I DEPARTMENT OF TRANSPORTATION HIGHWAYS DIVISION

FISCAL SHEET TOTAL YEAR NO. SHEETS

E14

HIGHWAY PROJ. NO.

HIGHWAY DIST. NO.


STATE


TUNNEL PLENUM & SHAFT
SECTION AND PROFILE
LIKELIKE HIGHWAY
WILSON TUNNEL ELECTRICAL
IMPROVEMENTS
HWY-OT-SMP-01

Scale: N.T.S.

THIS WORK WAS PREPARED BY ME OR UNDER MY SUPERVISION.

SHEET No. E14 OF 19 SHEETS

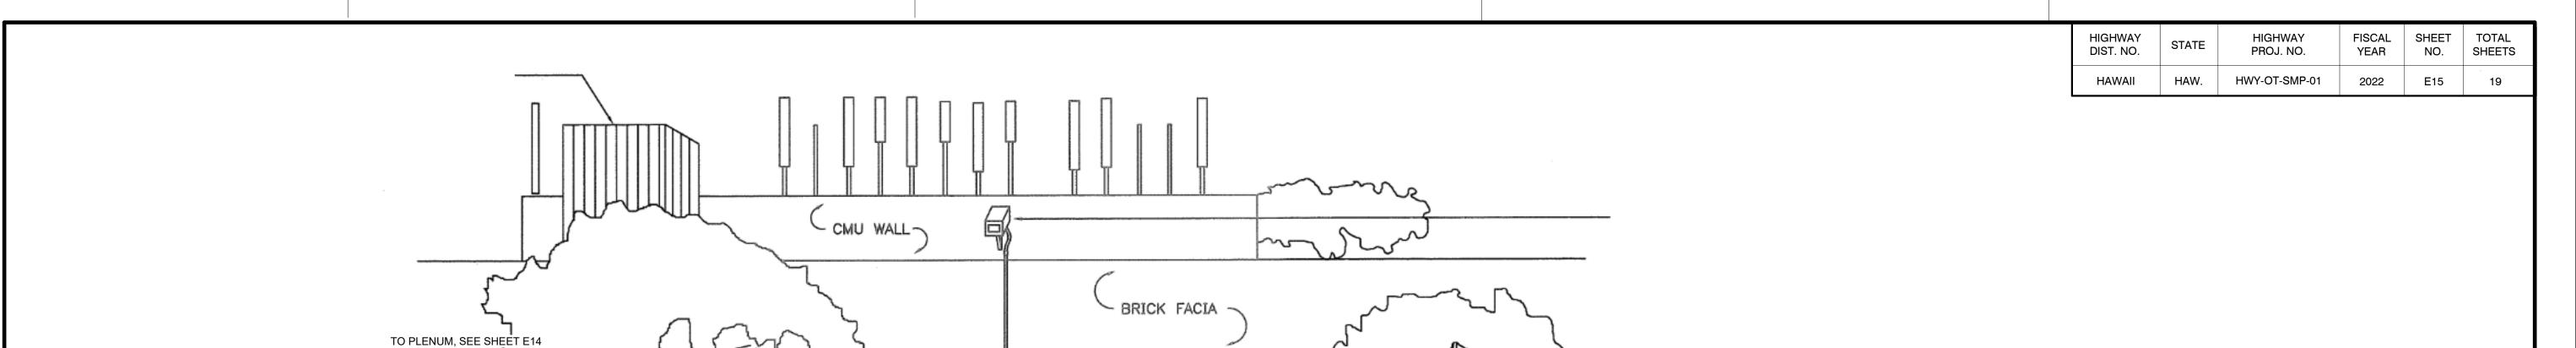

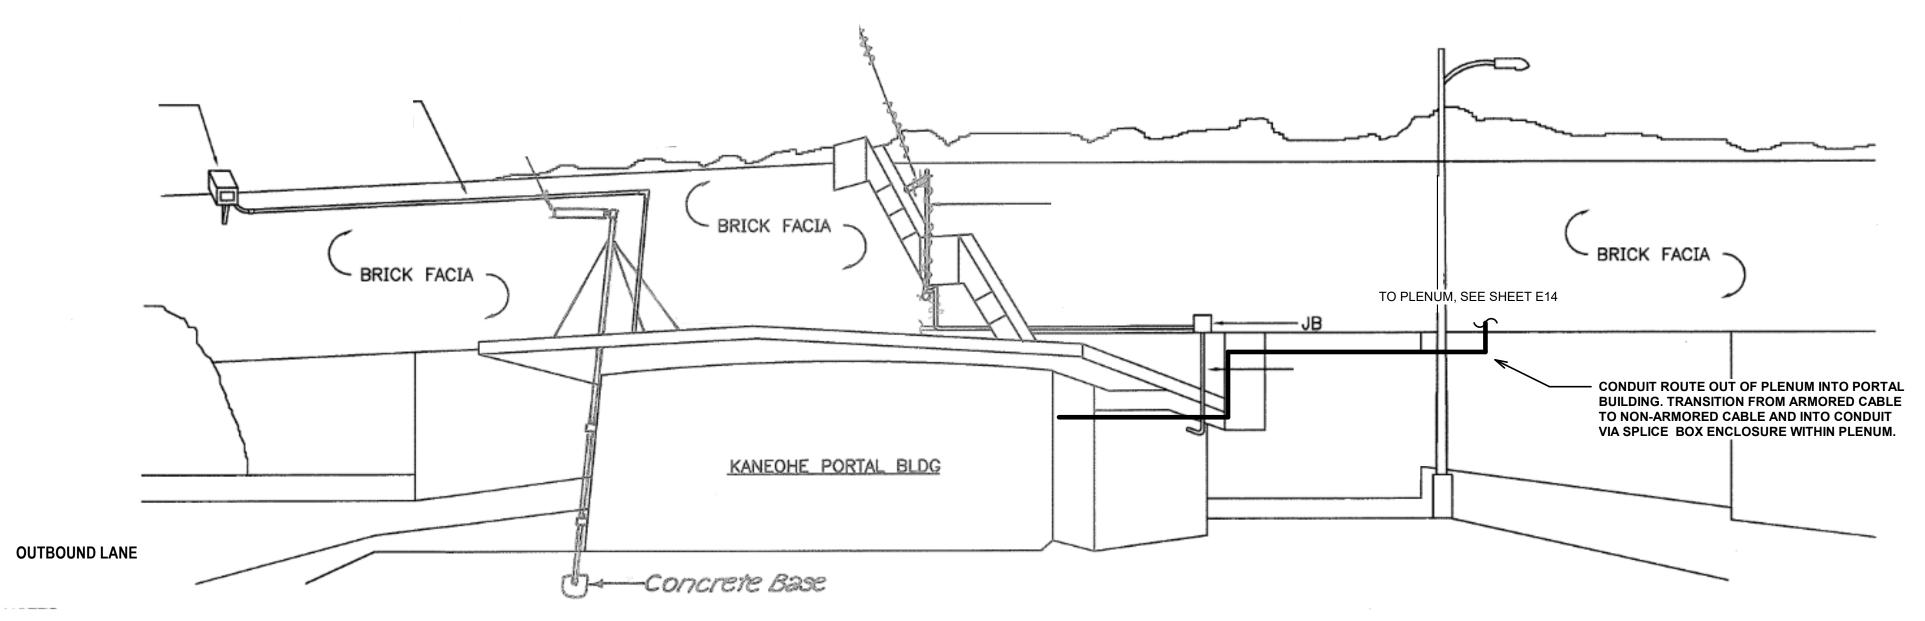

KALIHI PORTAL BLDG

THIS WORK WAS PREPARED BY ME OR UNDER MY SUPERVISION.

STATE OF HAWAI'I DEPARTMENT OF TRANSPORTATION HIGHWAYS DIVISION

PORTAL ELEVATIONS

LIKELIKE HIGHWAY
WILSON TUNNEL ELECTRICAL
IMPROVEMENTS HWY-OT-SMP-01

Scale: N.T.S


SHEET No. E15 OF 19 SHEETS


CONDUIT ROUTE OUT OF PLENUM INTO PORTAL BUILDING. TRANSITION FROM ARMORED CABLE TO NON-ARMORED CABLE AND INTO CONDUIT VIA SPLICE BOX ENCLOSURE WITHIN PLENUM.


INBOUND LANE

PORTAL ELEVATION

N.T.S.

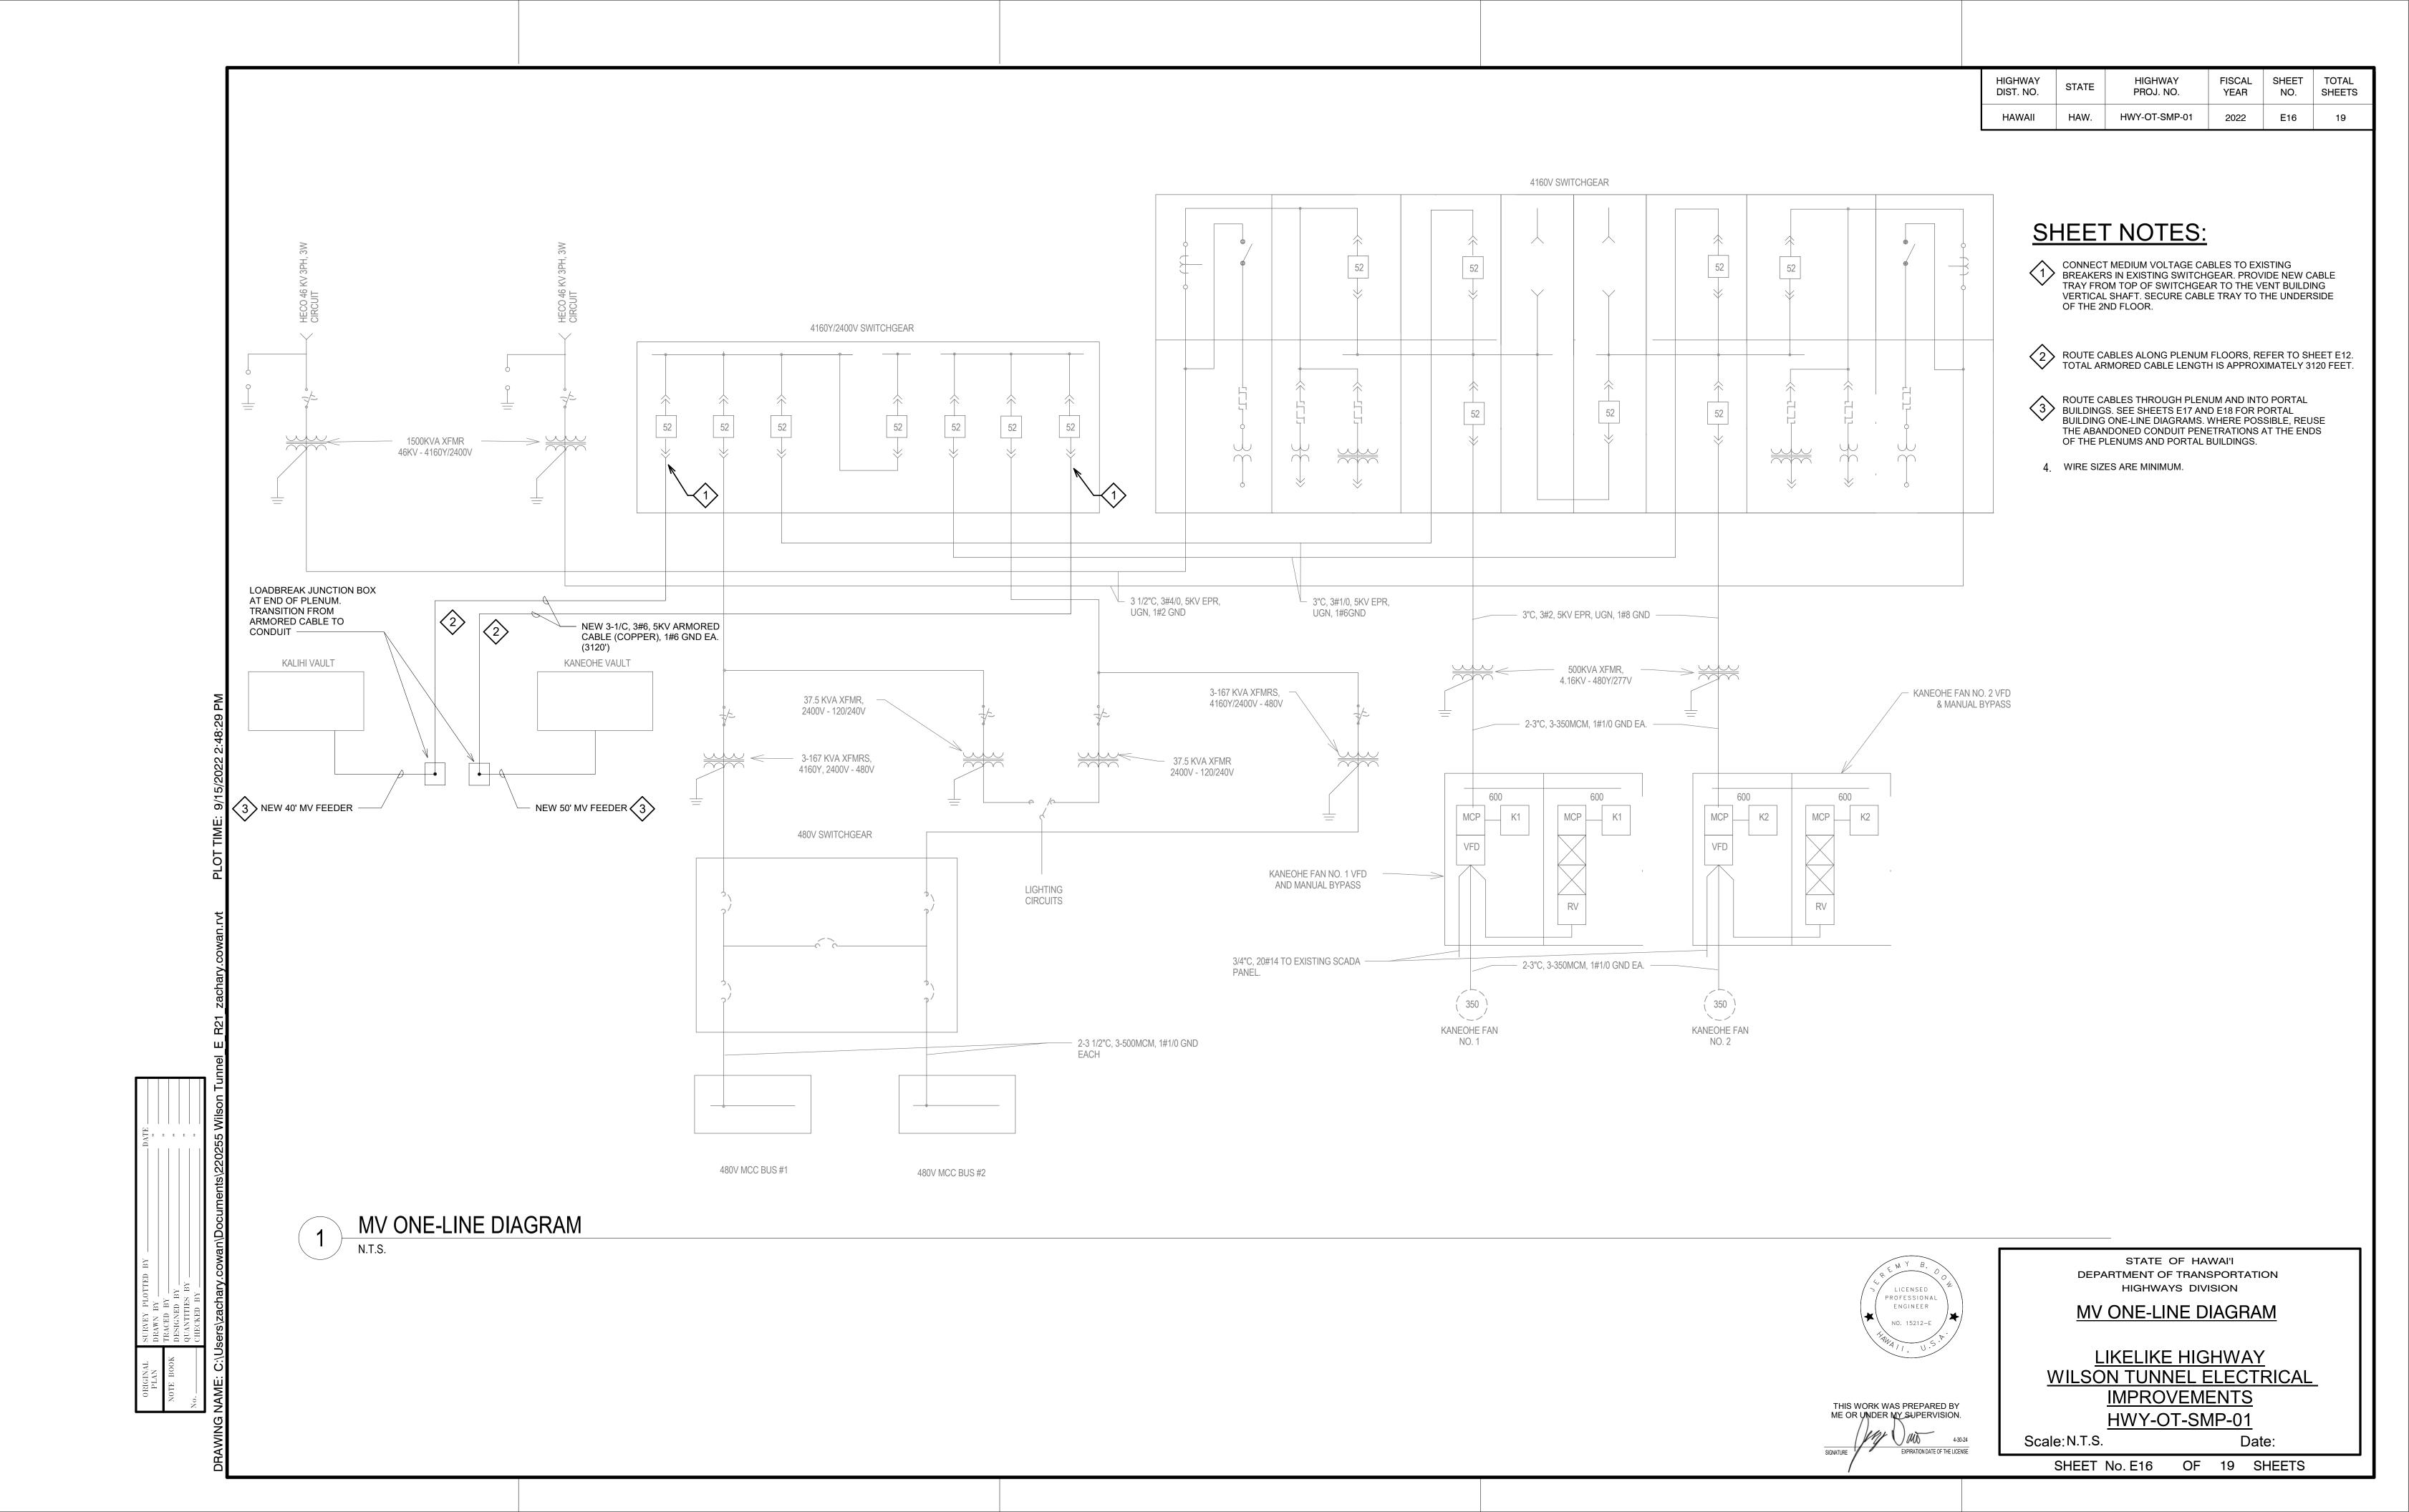

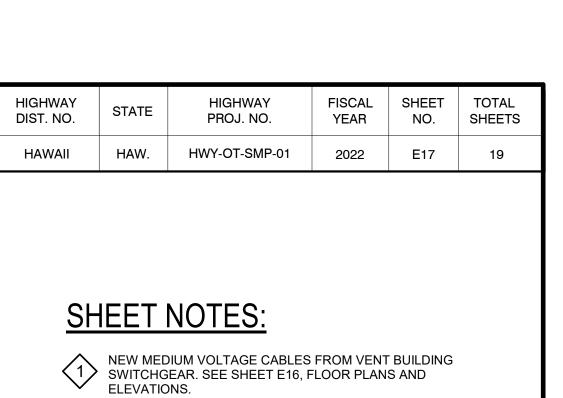

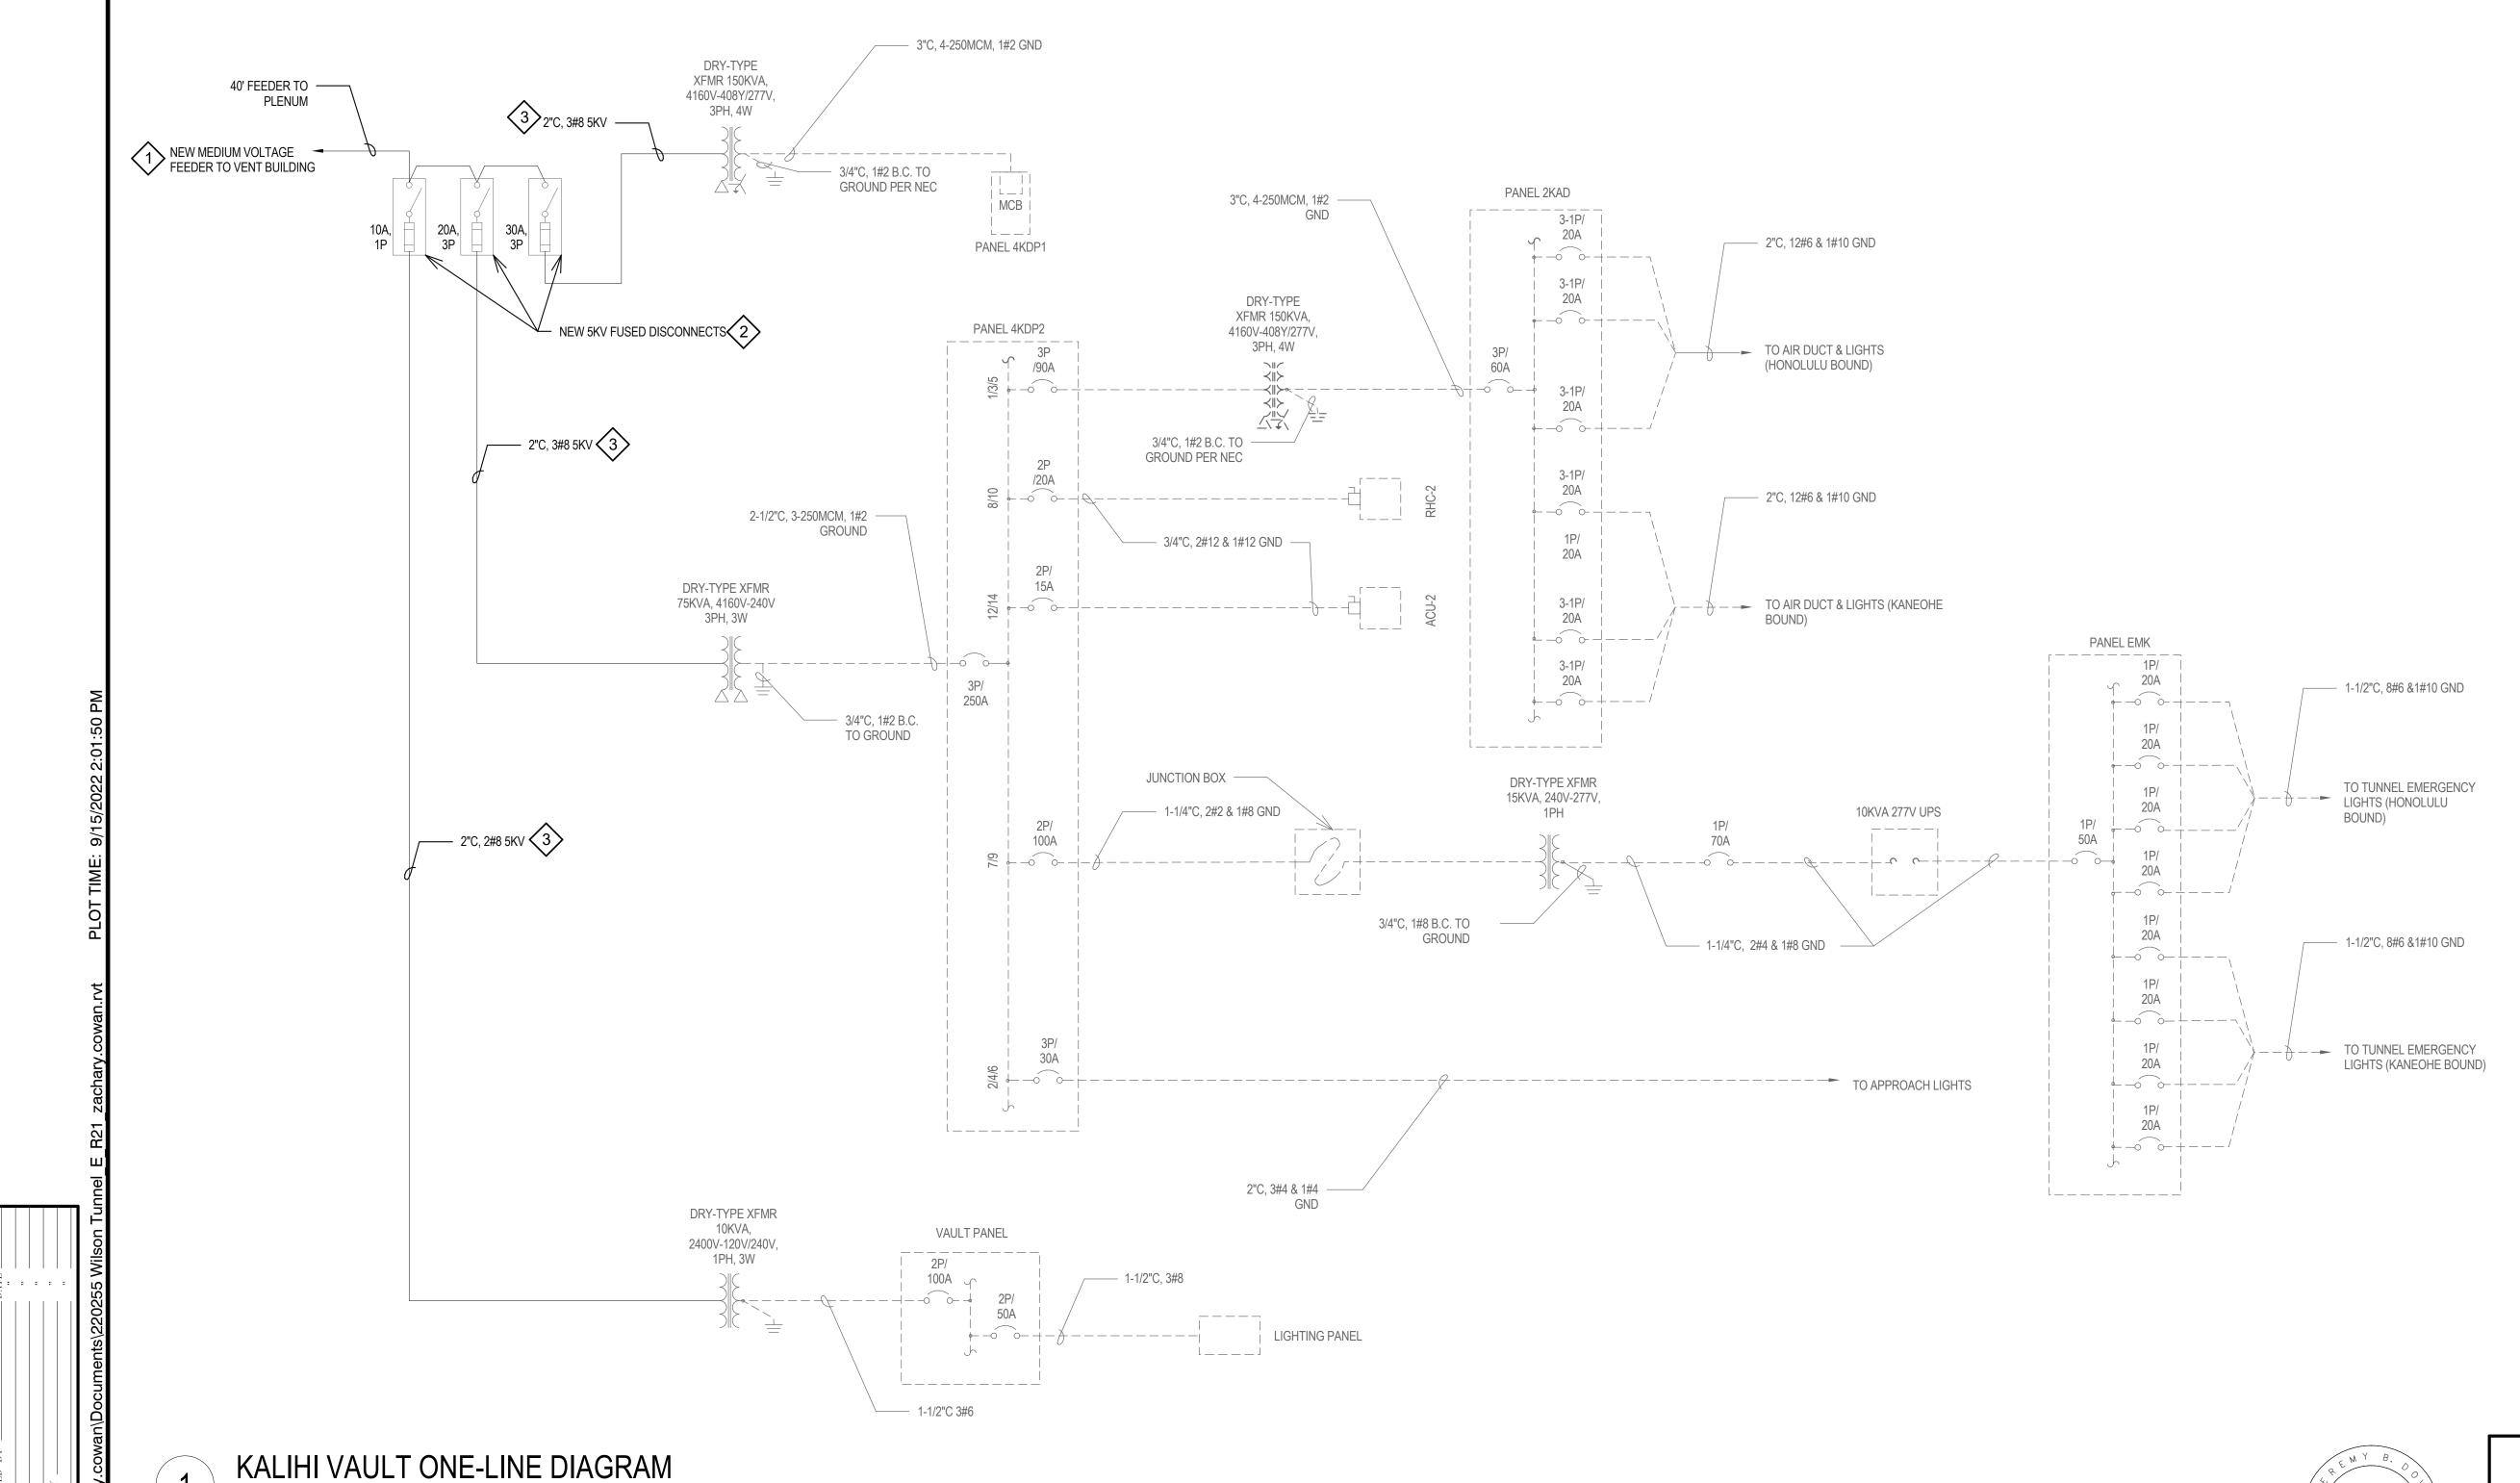

PROVIDE AND INSTALL NEW 5KV RATED DISCONNECT SWITCHES.

PROVIDE AND INSTALL NEW CABLES AND CONDUIT FROM NEW DISCONNECT SWITCHES TO EXISTING TRANSFOMERS.

4 WIRE SIZES ARE MINIMUM.

ENGINEER

THIS WORK WAS PREPARED BY ME OR UNDER MY SUPERVISION.

EXPIRATION DATE OF THE LICENSE

STATE OF HAWAI'I DEPARTMENT OF TRANSPORTATION HIGHWAYS DIVISION

KALIHI VAULT ONE-LINE **DIAGRAM** LIKELIKE HIGHWAY WILSON TUNNEL ELECTRICAL **IMPROVEMENTS** HWY-OT-SMP-01

Scale: N.T.S. SHEET No. E17 OF 19 SHEETS

